

DESIGN REVIEW COMMISSION AGENDA

Tuesday, May 20, 2025 – 6:30 P.M. Bartlett City Hall Assembly Chamber

Opening Prayer

Official Business of the Day

Minutes of the Thursday, April 15, 2025 Meeting

<u>Continued</u> Site Plan

 Bartlett Village Shopping Center, 5989 Bartlett Center Drive (Jesus Duarte, ARCH1010)

Open Discussion

The public shall be provided an opportunity to address the Board or Commission during an Open Discussion period at the end of each regular and special meeting of the governing body. Prior to the start of the meeting, individuals will be required to complete and present to the Clerk the Open Discussion Citizen form provided at each meeting. The Open Discussion period for regular and special meetings of the Board or Commission shall be limited to twenty (20) minutes. Individuals shall be allowed to speak for up to three (3) minutes each. Open Discussion periods will not be held for any meeting where there are no actionable items on the agenda or meetings where the governing body is conducting a disciplinary hearing for a member of the governing body or a person whose profession or activities fall within the jurisdiction of the governing body.

Adjourn

March 18, 2025 BARTLETT DESIGN REVIEW COMMISSION MINUTES

The Design Review Commission (DRC) met in the Bartlett City Hall Assembly Chamber on Tuesday, March 18, 2025 at 6:30 p.m. for a regularly scheduled meeting.

Members Present:

Ed Brooks
Jason Payne
Keith Whaley
Tyler Canup
Alderman Jack Young, Chairman
Steve Hodgkins

Members Absent:

Greg Evans, Vice Chairman Nick Taylor Stan Burton

<u>The following advisors were present:</u> Kim Taylor, Director of Planning; Leslie Brock, Planner; Melissa McAfee, Administrative Secretary; Ed McKenney, City Attorney; Trey Arthur, Director of Code Enforcement

Alderman Jack Young led the meeting.

Alderman Young led the Commission in prayer and the Pledge of Allegiance.

Alderman requested any changes to the minutes of the February 27, 2025 meeting.

The DRC noted a typo in the motion and second of last month's first agenda item.

A motion was made by Keith Whaley to approve the Minutes of the February 27, 2025 meeting with corrections. Tyler Canup seconded the motion. Voice Vote: All members present voted Yes. Motion carries. Minutes were approved with corrections.

NEW BUSINESS

Site Plan

 Bartlett Village Shopping Center, 5989 Bartlett Center Drive (Jesus Duarte, Arch 1010) **INTRODUCTION**: Mr. Jesus Duarte, with Arch 1010, is requesting Design Review Commission approval of a revised site plan for the Bartlett Village Shopping Center. The subject property is located at 5989 Bartlett Center Drive, and it is within the "CG-MS" General Business with a Main Street Overlay Zoning District.

BACKGROUND: On June 7, 1986, the DRC approved the site plan for the Bartlett Village Shopping Center. The owner/applicant has received multiple Code Compliance, Notices of Violation dating back to June 25, 2018, concerning property maintenance or lack thereof.

DISCUSSION: The specific request by the applicant is for DRC approval of building elevations, lighting details, and dumpster enclosure. The specifics of the site plan are as follows:

Elevations: The Bartlett Village Center has two front elevations, the east and north elevation. A fabric awning originally covered the storefronts of these two elevations and a portion of the south elevation. The awnings fell into disrepair and were partially removed. The remainder of the awnings will be demolished and the EFIS will be patched. With the removal of the awnings, a structural overhang which held the awning frame will remain. All four elevations will be painted Sherwin Williams "Off White" (SW1095). The gutters and downspouts will be painted Sherwin Williams "Peppercorn" (SW7674). All double and single personnel doors will be painted Sherwin Williams "Off White" (SW1095).

Lighting: The proposed changes to the lighting are as follows: existing recessed lighting at the store entrances along the north elevation and the existing pole lights will remain. The existing fluorescent lighting along the north elevation will be removed and replaced with 5 Guardco 4K LED black down-facing wall sconces. The existing lighting on the east elevation will be removed and replaced with 6 Caliber Plus C73 Series 3.5K LED black down facing wall sconces. The existing lighting on the south elevation will be replaced with 3 Guardco 4K LED black down facing wall sconces. The foot candles for the north elevation will be 3.23 FC. The average foot candles for the east elevation is 3.23 FC.

Dumpster Enclosure: The existing dumpster will be moved from the current spot in the drive aisle on the southwest corner of the property. The new dumpster enclosure will be located in a loading area on the south side of the building. The dumpster enclosure will consist of treated lumber pickets attached to a steel frame with a treated lumber cap. The gate will feature treated lumber attached to a steel frame with two drop pins. The dumpster enclosure will be painted Sherwin Williams "Peppercorn" (SW7674).

Recommendation: Approval with conditions.

Planning Conditions:

- 1. The applicant shall make certain the site plan is consistent throughout the plans and match the lighting plan.
- 2. The applicant shall properly patch and repair the parking lot before coating the asphalt and restriping.
- 3. The applicant shall remove the existing fluorescent lighting strips on the north elevation as they are not UL Certified.
- 4. The applicant shall paint the building coping cap Sherwin Williams "Peppercorn" (SW7674).
- 5. The applicant shall replace the removed awnings with either fabric or metal awnings.
- 6. The applicant shall remove the plywood and replace the windows in the east storefront in compliance with the original site plan.
- 7. The applicant shall patch or fully repair all damaged EFIS with like materials.
- 8. The applicant shall reposition the rodent traps on the front of the building more hidden locations. However, well-kept landscaping and better kept grounds will go a long way in rodent control.
- 9. Irrigation and maintenance are required for all planting on the landscape plan indefinitely. Applicant shall replace missing or dead plants listed in the landscaping plan approved June, 1986. Bartlett Zoning Ordinance Article VI, Section 17 states, "Should the property owner fail to maintain these landscape screens and landscape areas in accordance with approvals of the Planning Commission and the Design Review Commission, it will be deemed a violation of this Ordinance.
- 10. All proposed signage shall be submitted on a separate application to the Design Review Commission.
- 11. The owner/applicant shall identify all utilities on site by contacting Tennessee One Call at 811 before commencing any site work.
- 12. The owner/applicant shall be present at the meeting in order to make decisions relative to any changes that may be suggested by the Design Review Commission.

Engineering Conditions: None.

Ms. Brock noted that the subject property has many active violations that have been there for several years now.

Martin Chow, building owner, stepped forward.

Mr. Chow stated that he is in agreement with most staff conditions, but not Planning Condition #5. He would prefer to exclude awnings from the building

ogive it a cleaner look. He also would like clarification on Planning Conditions #6 and #9.

Ms. Brock stated that staff prefer awnings are replaced, not excluded. The eastern building elevation does not provide any shield from rain to patrons entering tenant spaces on that side. Awnings would allow shielding from rain and prevent rain from leaking into tenant spaces each time a door is opening during a storm.

Mr. Chow stated that Planning Condition #9 requires irrigation and landscaping to match the plan approved in 1986, but he does not know what was on this plan since he did not own the building back then.

Planning Director Kim Taylor stated that staff can provide the approved 1986 DRC Site Plan for him to reference. Staff is okay with updated plant species replacing dead or missing plants since the optimal plant species of today is likely different than whatever is on the 1986 plan. Irrigation is required still.

Alderman Young asked why Mr. Chow has been out of compliance with property maintenance requirements for so many years.

Mr. Chow stated that tonight's plan should address all code compliance issues. He was under the impression that a DRC Site Plan had to be re-approved in order for him to make any exterior repairs to the building.

Alderman Young stated that DRC approval is not needed to make repairs to a building if those repairs are bringing the building back to the condition it was in prior to damage.

After several minutes of back and forth between Mr. Chow and the DRC, multiple DRC members concluded that the conditions Mr. Chow is in agreement with and the submitted plans do not align with what is being proposed tonight. They would like to see these changes reflected in the plans.

Ed Brooks made motion to defer the DRC Site Plan for Bartlett Village Shopping Center at 5989 Bartlett Center Drive until staff and Mr. Chow can come to an agreement. The DRC will reconvene at next month's meeting to view revised plans and vote. Keith Whaley seconded the motion. Roll Call Vote: Keith Whaley, Ed Brooks, Jason Payne, Jack Young, and Steve Hodgkins voted yes. Tyler Canup abstained. Motion carries.

Open Discussion

Alderman Young called for further discussion. Hearing none.

Meeting adjourned at 6:51 p.m.

Design Review Commission

Tuesday, May 20, 2025 City Hall 6:30 P.M.

OLD BUSINESS
Continued
Site Plan

1. Bartlett Village Shopping Center, 5989 Bartlett Center Drive (Jesus Duarte, Arch 1010)

INTRODUCTION: Mr. Jesus Duarte, with Arch 1010, is requesting Design Review Commission approval of a revised site plan for the Bartlett Village Shopping Center. The subject property is located at 5989 Bartlett Center Drive, and it is within the "CG-MS" General Business with a Main Street Overlay Zoning District.

BACKGROUND: On March 14, 2024, the DRC continued the Site Plan for Bartlett Village Shopping Center until the submitted Site Plan and items proposed by the applicant are in agreement. On March 30, 2025, Staff met with the applicant to work out the details of the property maintenance issues and the Site Plan.

DISCUSSION: The specific request by the applicant is for DRC approval of building elevations, lighting details, and dumpster enclosure. The specifics of the site plan are as follows:

Elevations: The Bartlett Village Center has two front elevations, the east and north elevation. A fabric awning originally covered the storefronts of these two elevations and a portion of the south elevation. The awnings fell into disrepair and were partially removed. The remainder of the awnings will be demolished, and new awnings will be installed on the east and a portion of the north elevation. The fire-resistant fabric awnings will be black.

Once the EIFS is repaired and patched, all four elevations will be painted Sherwin Williams "Shoji White" (SW7042). The gutters and downspouts will be painted Sherwin Williams "Peppercorn" (SW7674). All double and single personnel doors will be painted Sherwin Williams "Shoji White" (SW7042).

Lighting: The proposed changes to the lighting are as follows: existing recessed lighting at the store entrances along the north elevation and the existing pole lights will remain. The existing fluorescent lighting along the north elevation will be removed and replaced with 5 Tucana III 4K LED black, down facing wall packs. The existing lighting on the east elevation will be removed and replaced with 6 Caliber Plus C73 Series 3.5K LED black down facing wall sconces. The existing lighting on the south elevation will be replaced with 3 Tucana III 4K LED

black, down facing wall packs. The foot candles for the north elevation will be 3.23 FC. The average foot candles for the east elevation is 3.23 FC.

Dumpster Enclosure: The existing dumpster will be moved from the current spot in the drive aisle on the southwest corner of the property. The new dumpster enclosure will be located in a loading area on the south side of the building. The dumpster enclosure will consist of treated lumber pickets attached to a steel frame with a treated lumber cap. The gate will feature treated lumber attached to a steel frame with two drop pins. The dumpster enclosure will be painted Sherwin Williams "Peppercorn" (SW7674).

Recommendation: Approval with conditions.

Planning Comments:

- 1. On March 30, 2024, the dumpster enclosure was approved by staff and applicant received his building permit.
- 2. The applicant agreed to repair the missing windows by properly repairing with a wall.
- 3. The applicant has agreed to replacing the awnings with new sleeker design, fabric awnings.
- 4. The applicant has agreed to replace all dead or missing landscaping from the landscape plan approved June 1986. He will cut back overgrown trees and agrees to maintain the landscaping plan indefinitely.

Planning Conditions:

- 1. The applicant shall make certain the site plan is consistent throughout the plans and match the lighting plan.
- 2. The applicant shall properly patch and repair the parking lot before coating the asphalt and restriping.
- 3. The applicant shall remove the existing fluorescent lighting strips on the north elevation as they are not UL Certified.
- 4. The applicant shall repaint the parking lot pole light with a similar paint color or Sherwin Williams "Peppercorn" (SW7674)
- 5. The applicant shall paint the building coping cap Sherwin Williams "Peppercorn" (SW7674).
- 6. The applicant shall patch or fully repair all damaged EIFS with like materials.
- 7. The applicant shall reposition the rodent traps on the front of the building more hidden locations.
- 8. Irrigation and maintenance are required for all planting on the landscape plan indefinitely.
- 9. All proposed signage shall be submitted on a separate application to the Design Review Commission.
- 10. The owner/applicant shall identify all utilities on site by contacting Tennessee One Call at 811 before commencing any site work.

11. The owner/applicant shall be present at the meeting in order to make decisions relative to any changes that may be suggested by the Design Review Commission.

MR. MARTIN CHOW BARTLETT SHOPPING CENTER

6001 BARTLETT CENTER DRIVE, BARTLETT TN

CONSTRUCTION DOCUMENTS

05.12.2025



ARCH 1010

676 Marshall Ave. Suite 101 www.arch1010.com CONSULTANT / SEAL


DEVELOPER/OWNER MR. MARTIN CHOW

PROJECT LOGO

COVER SHEET

05.12.2025

VICINITY MAP

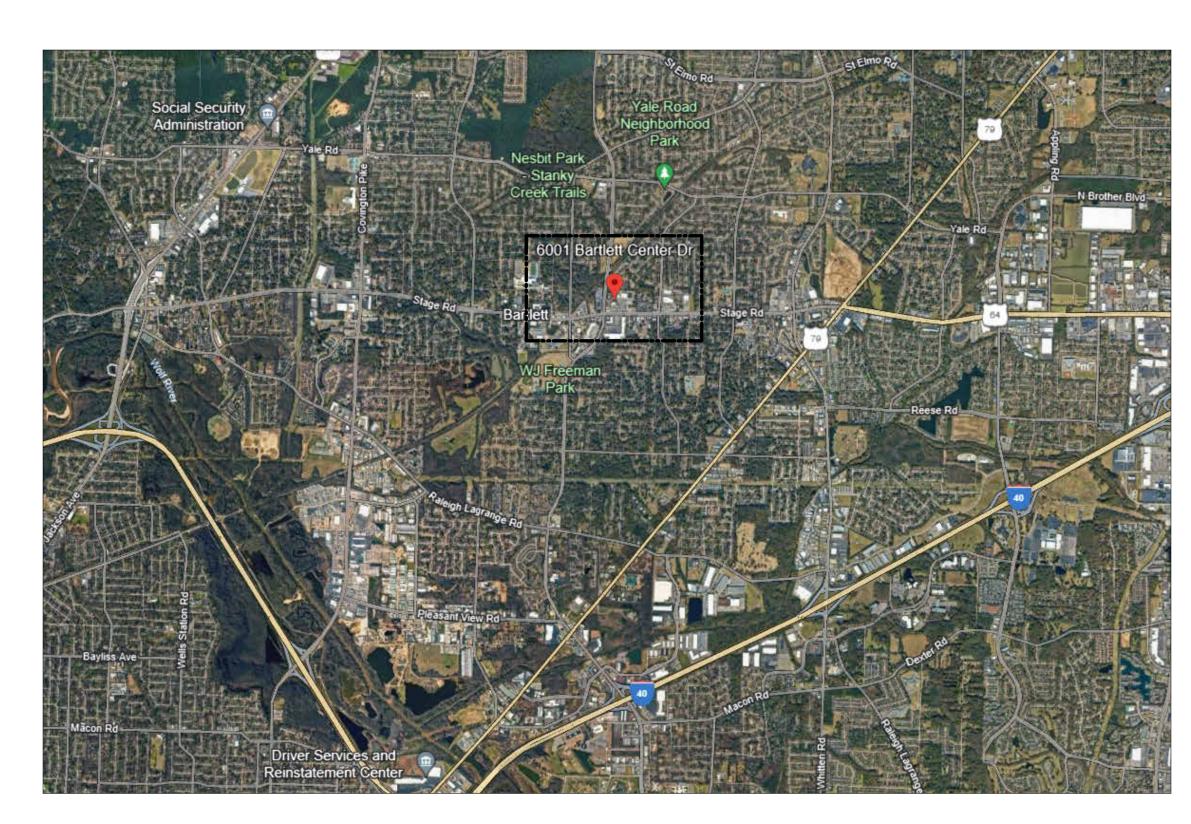

DESIGN TEAM

676 Marshall Ave, Suite 101 Memphis, TN 38104 P. (901) 497-6563

INDEX TO DRAWINGS

GENERAL	
T0.0	COVER SHEET
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ARCHITECTUR	RAL
D0.0	DEMO AXO VIEWS
D1.0	DEMO SITE PLAN
D2.0	DEMO RCP
D3.0	DEMO ELEVATIONS
A1.0	ARCHITECTURAL SITE PLAN
A1.1	SITE DETAILS
A2.0	FLOOR PLAN
A2.2	REFLECTED CEILING PLAN
A3.0	EXTERIOR ELEVATIONS
ELECTRICAL	
E100	PHOTOMETRIC PLAN

ABBREVIATIONS

INTERIOR JOINT

	EVIATIONS		
BV.	ABOVE	LARCH.	LANDSCAPE ARCHITECT
C	AIR CONDITIONING	LAV.	LAVATORY
CM	ALUMINIUM COMPOSITE MATERIAL	LKB.	LOCKABLE
CT	ACOUSTICAL CEILING TILE	LOW.	LOWER
DA	AMERICANS WITH DISABILITIES ACT	LT.	LIGHT
DJ.	ADJACENT	MAT. MAX.	MATERIAL
FF GG.	ABOVE FINISHED FLOOR AGGREGATE	MCP	MAXIMUM MELANINE COATED PARTICLE BOARD
LT.	ALTERNATE	MECH.	MECHANICAL
LUM.	ALUMINIUM	MEMB.	MEMBRANE
NOD.	ANODIZED	MEP	MECHANICAL, ELECTRICAL & PLUMBING
PPROX.	APPROXIMATE	MFG.	MANUFACTURER
RCH.	ARCHITECTURAL	MIN	MINIMUM
D.	BOARD	MISC.	MISCELLANEOUS
LDG.	BUILDING	MOD. BIT. M.R.	MODIFIED BITUMEN MOISTURE RESISTANT
LK'G .O.	BLOCKING BOTTOM OF	MTL.	METAL
.O. OT.	BOTTOM OF	MULL.	MULLION
TW.	BETWEEN	NA	NOT AVAILABLE
YND.	BEYOND	NIC	NOT IN CONTRACT
DR	CARD READER	NO.	NUMBER
.G.	CORNER GUARD	NOM.	NOMINAL NOT TO SCALE
.J.	CONTROL JOINT	NTS O.C.	NOT TO SCALE ON CENTER
.L.	CENTER LINE	O.D.	OUTSIDE DIAMETER
LG. LR.	CEILING CLEAR / CLEARANCE	OFCI	OWNER FURNISHED, CONTRACTOR
LR. LSR.	CLOSER CLOSER	OFOI	OWNER FURNISHED, OWNER INSTALLED
MU	CONCRETE MASONRY UNIT	OP'G.	OPENING
OL.	COLUMN	OPP.	OPPOSITE
ONC.	CONCRETE	PERF.	PERFORATED
ONN.	CONNECTION	P-LAM	PLASTIC LAMINATE
ONST.	CONSTRUCTION	PLUMB. PRE-FIN.	PLUMBING PRE-FINISHED
ONT.	CONTINUOUS	PROG.	PROGRAMMING
OORD. ORR.	CORRIDOR	PSF	POUNDS PER SQUARE FOOT
ORRUG.	CORRIDOR CORRUGATED	PSI	POUNDS PER SQUARE INCH
PT.	CARPET	P.T.	PRESSURE-TREATED
. т. .т.	CERAMIC TILE	PTD.	PAINTED
TR.	CENTER	PWD.	PLYWOOD
BL.	DOUBLE	Q.S. RCP	QUARTZ SURFACE REFLECTED CEILING PLAN
EMO.	DEMOLITION	REF.	REFER / REFERENCE
.F.	DRINKING FOUNTAIN	REF	REFRIGERATOR
IA.	DIAMETER	REINF.	REINFORCEMENT / REINFORCING
IM. N.	DIMENSION DOWN	REQ'D.	REQUIRED
S	DOWN SPOUT	RM.	ROOM
TL.	DETAIL	RMC	RIGID METAL CONDUIT
WG.	DRAWING(S)	R.O. RSF	ROUGH OPENING RESILIENT SHEET FLOORING
A.	EACH	RTF	RESILIENT TILE FLOORING
IFS	EXTERIOR INSULATION FINISH SYSTEM	RWB	RESILIENT WALL BASE
.J.	EXPANSION JOINT	SCHED.	SCHEDULE
L.	ELEVATION	SHWR.	SHOWER
LEC. LEV.	ELECTRICAL ELEVATOR	SIM.	SIMILAR
NLG'D	ENLARGED	SPEC.	SPECIFICATION
OS	EDGE OF SLAB	S.S.	STAINLESS STEEL
Q.	EQUAL	SSF STC	SOLID SURFACE SOUND TRANSMISSION COEFFICIENT
QUIP.	EQUIPMENT	STD.	STANDARD
.W.	EACH WAY	STL.	STEEL
XIST.	EXISTING	STRUCT.	STRUCTURE / STRUCTURAL
XP.	EXPANSION	SURF.	SURFACE
XT. .D.	EXTERIOR FLOOR DRAIN	SVF	SHEET VINYL FLOORING
.Б. .Е.	FIRE EXTINGUISHER	TEL.	TELEPHONE
EC	FIRE EXTINGUISHER CABINET	TEMP.	TEMPERATURE
FE	FIXTURES, FURNITURE AND EQUIPMENT	TLT. T.O.	TOILET TOP OF
IN.	FINISH	TYP.	TYPICAL
LR.	FLOOR	U.C.	UNDER COUNTER
.O.	FACE OF	U.G.	UNDERGROUND
.R.	FIRE-RESISTANT	UNO	UNLESS NOTED OTHERWISE
T.	FOOT / FEET	VAR.	VARIES
TG. URR'G.	FOOTING ELIPPING	VCT	VINYL COMPOSITE TILE
ORR'G. A.	FURRING GAUGE	VERT.	VERTICAL
A. YP.	GYPSUM	VIF V.T.	VERIFY IN FIELD VINYL TILE
DW	HARDWARE	V.T. VWC	VINYL TILE VINYL WALL COVERING
DWD	HARDWOOD	W/	WITH
.M.	HOLLOW METAL	W.B.	WEATHER BARRIER
ORIZ.	HORIZONTAL	W.C.	WATER CLOSET
R.	HOUR	W/C	WHEELCHAIR
SS -	HOLLOW STRUCTURAL SECTION	WD.	WOOD
T.	HEIGHT	WIN.	WINDOW
BC D.	INTERNATIONAL BUILDING CODE INSIDE DIAMETER	W.H. W/O	WATER HEATER WITHOUT
D. ISUL.	INSIDE DIAMETER INSULATION	W.P.	WORK POINT

WORK POINT

WEATHER STRIPPING

GOVERNING CODES:

BUILDING CODE:	2021 International Building Code with Local Amendments
ELECTRICAL CODE:	2020 National Electric Code with Local Amendments
MECHANICAL CODE:	2021 International Mechanical Code with Loca Amendments
PLUMBING CODE:	2021 International Plumbing Code with Local Amendments

Amendments

2021 International Fuel Gas Code with Local

GENERAL NOTES

GAS CODE:

1. The General Contractor for this Project shall address the coordination of the entire scope of work, from the beginning of the construction process through final close-out. The scope of work shall include, but is not limited to, preparation of all coordination drawings and diagrams, all schedules for completion, and control of site utilization.

2. The General Contractor is solely responsible for all procedures necessary for the completion of this Project.

3. The General Contractor for this Project shall include all materials and labor necessary for the completion of the entire scope of work. All materials, labor, tools, equipment, machinery, transportation, heat, water, utilities, and other facilities and services required for safe and proper execution are to be furnished and paid for by the General Contractor.

4. Information contained in the Contract Documents shall be interpreted by the Architect. The documents show an overview of the work required under this Contract, as well as other requirements or conditions which might impact the Project. The Contract Documents generally indicate the concept and intent of the Project, and are not meant to necessarily show all conditions or details.

5. Drawings are furnished to show design intent for construction only and do not show every condition or aspect of construction. Dimensions shown take precedent over graphic representations. Dimensions shown to existing elements are to be field verified by the General Contractor. Drawings are not to be scaled. Larger scale details take precedence over smaller scale details. The General Contractor is to inform the Architect of any discrepancies prior to proceeding with any work.

6. The Contract Documents are designed to reflect a particular occupancy type and use for the structure and associated systems and facilities described. Compliance with all codes and regulations concerning the use and occupancy of the structure is intended. All parts of this work shall adhere to any requirements indicated in the Contract Documents.

Plumbing will be the responsibility of the General Contractor. 8. Discrepancies between portions of Contract Documents should be clarified by the General Contractor and Architect

7. Coordination of all Civil, Structural, Mechanical, Electrical, and

prior to proceeding with any work in question. 9. The General Contractor shall comply with all rules and regulations as defined by the ADA Guidelines.

10. Final clean-up of the building and site shall be the responsibility of the General Contractor. Building and site shall be turned over in a clean and new condition to the Owner.

GENERAL DEMOLITION NOTES

13. The potential of encountering latent asbestos-containing

materials, mold, and other hazardous materials exists on this

Immediately notify the Owner and Architect so that corrective

project. If any materials suspected of containing hazardous materials are encountered, do not disturb the materials.

14. Maintain ratings for doors and walls at all intersections,

15. Existing utilities to remain in service and protected from

16. Where utility services are required to be removed, relocated,

or abandoned, provide bypass connection to maintain continuity

off pipes or conduit in walls or partitions to be removed. Cap,

valve, or plug and seal the remaining portion of pipe or conduit

17. Protect walls, ceilings, floors, and other existing finish work

18. Promptly patch and repair holes and damaged surfaces

finishes of patched areas and extend finish restoration into

19. When Civil, Structural, Mechanical, Electrical, or Plumbing

encountered, investigate and measure the nature and extent of

20. Sweep the project site broom-clean and change filters on air-

handling equipment scheduled to remain upon completion of

demolition. The spaces should be stripped, cleaned, and made

21. Place markers to indicate location of disconnected services.

Verify service lines and capping locations on project Record

22. Provide Owner/Building-Manager with Record Drawings

and accurately locate capped utilities and other Structural,

Mechanical, Electrical, and Plumbing conditions.

consisting of red-lined plans at project close-out which identify

the conflict. Promptly submit a written report to the Architect

elemens conflict with the intended function or design are

caused to adjacent construction by demolition. Restore exposed

that are to remain and are exposed during demolition.

adjoining construction in a manner that eliminates

evidence of patching and refinishing.

before proceeding with demolition.

ready for new construction.

of service to other parts of the building(s) before proceeding. Cut-

connections, and penetrations as required per applicable building

action can be taken.

damage during demolition.

after bypassing.

1. The General Contractor is responsible for obtaining the Owner's requirements prior to beginning work. All work shall be done in accordance with the Owner's requirements and standard operating procedures for demolition activities.

2. The General Contractor shall coordinate with local code officials to ensure that demolition operations are conducted in compliance with all applicable codes.

3. The General Contractor shall provide and maintain all existing exits, exit lighting, fire protection devices, and alarms to conform to local building requirements.

4. Owner to arrange shut-off of utilities when required by the General Contractor. Do not start demolition until utility disconnection and sealing have been completed and verified in

5. Throughout all phases of demolition and construction the Contractor shall be responsible for conducting demolition operations to prevent damage to adjacent buildings, structures, and other facilities and injury to persons. Provide sufficient protection within and beyond demolition/construction areas to eliminate any risk to construction personnel and/or other thirdparty individuals. Erect and maintain dust-proof partitions and

temporary enclosures to limit dust migration and to separate

6. Maintain structural integrity of the building.

areas from fumes and noise as required.

7. Provide and maintain interior shoring, bracing, or structural support to preserve stability and prevent movement, settlement, or collapse of items to be selectively demolished and items which are immediately adjacent to those being removed.

8. Perform surveys as the work progresses to detect hazards resulting from the selective demolition.

9. Demolish and remove existing construction only to extent required by new construction and as indicated. Use methods required to complete work within limitations of governing

regulations and as follows: A. Neatly cut openings and holes plumb, square, and true to dimensions required. Use cutting methods least likely to damage construction to remain or adjoining construction.

B. Cut or drill from the exposed or finished side into concealed surface to avoid marring existing finished **C.** Do not use cutting torches until work area is cleared of flammable materials. At concealed spaces, verify condition and contents of hidden space before starting flame-cutting operations. **D.** Maintain adequate ventilation when using cutting

E. Remove decayed, vermin-infested or otherwise dangerous and/or unsuitable materials and promptly dispose of off-site. F. Locate demolition equipment throughout the structure and remove debris and material so as not to impose excessive loads on supporting structure.

10. Debris resulting from demolition and construction shall be removed daily from the construction site to a waste area provided by the Contractor in coordination with the Owner and Building

G. Burning of materials on site is not permitted.

11. Limit use of the premises to construction activities in areas indicated in the scope of the project. Allow Owner occupancy and use by building's drivers and maintenance/service personnel at

12. All driveways and circulation paths to remain open and available to Owner, or Contractor to provide protected temporary means of egress during necessary phases of construction as required per applicable building codes.

BUILDING DATA

BUILDING: EXISTING FLOOR AREA 13,075

USE & CONSTRUCTION: OCCUPANCY CLASSIFICATION: (According to Chapter 3 of International Building Code 2021)

KEY LEGEND

DOOR NUMBER KEY WINDOW NUMBER KEY WALL NUMBER KEY EXISTING STRUCTURAL GRID NEW STRUCTURAL GRID SPOT ELEVATION INTERIOR ELEVATION KEY EXTERIOR ELEVATION KEY ENLARGED PLAN / DETAIL KEY

MATCHLINE VIEW REFERENCE KEY

SHEET TITLE **GENERAL**

INFORMATION

ARCH 1010

676 Marshall Ave. Suite 101 Memphis, TN 38103 901.497.6563

www.arch1010.com

PROJECT NAME

CENTER

LOCATION

BARTLETT SHOPPING

6001 BARTLETT CENTER DRIVE, BARTLETT TN

PROJECT NUMBER

DEVELOPER/OWNER

MR. MARTIN CHOW


PROJECT LOGO

CONSULTANT / SEAL

05.12.2025 SHEET NUMBER



CONSULTANT / SEAL

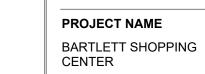

LOCATION 6001 BARTLETT CENTER DRIVE, BARTLETT TN

PROJECT NUMBER

DEVELOPER/OWNER MR. MARTIN CHOW

PROJECT LOGO

INFORMATION












SHEET TITLE EXT. RENDERINGS

05.12.2025 SHEET NUMBER

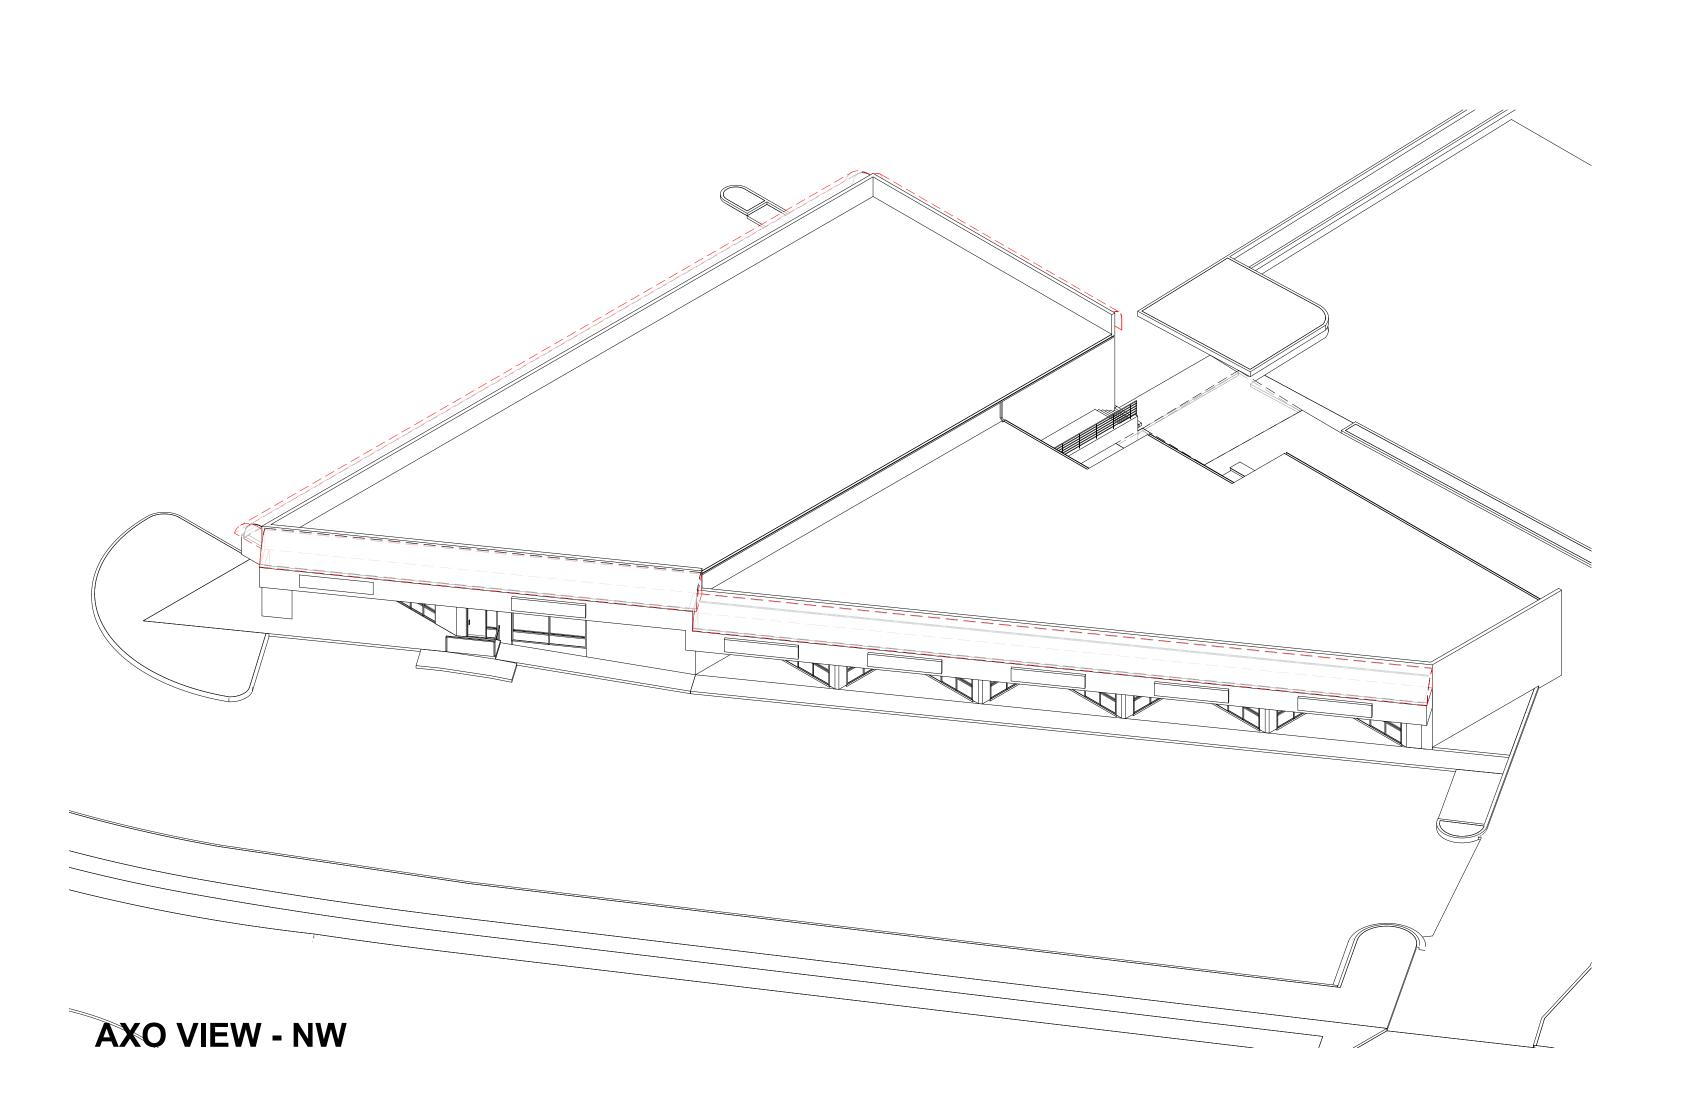


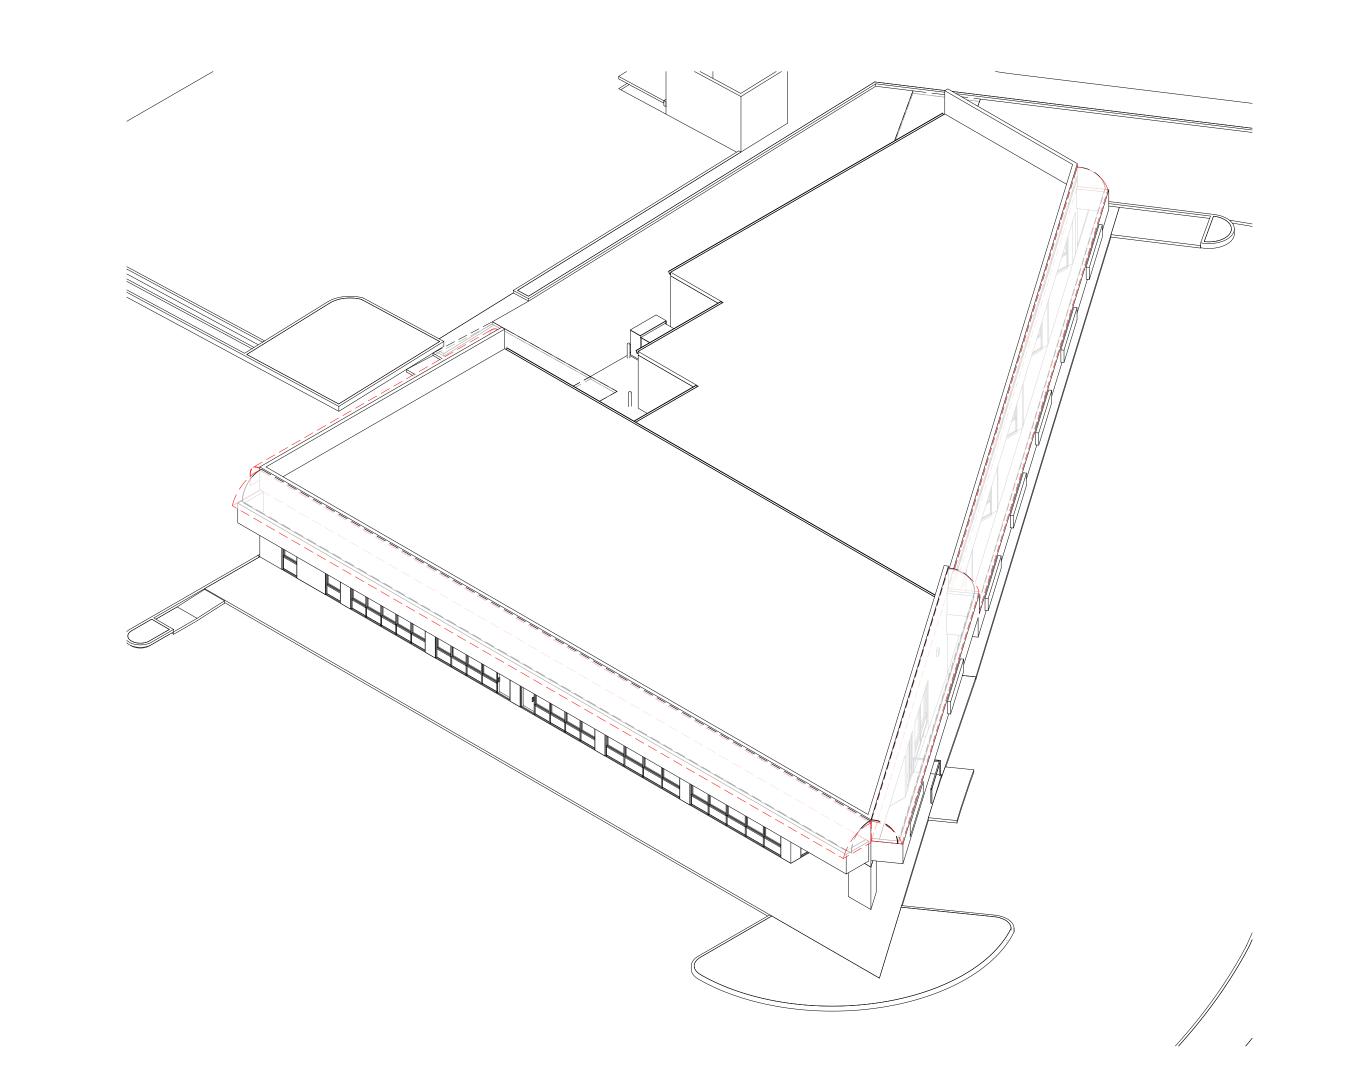

AXO VIEW - NE

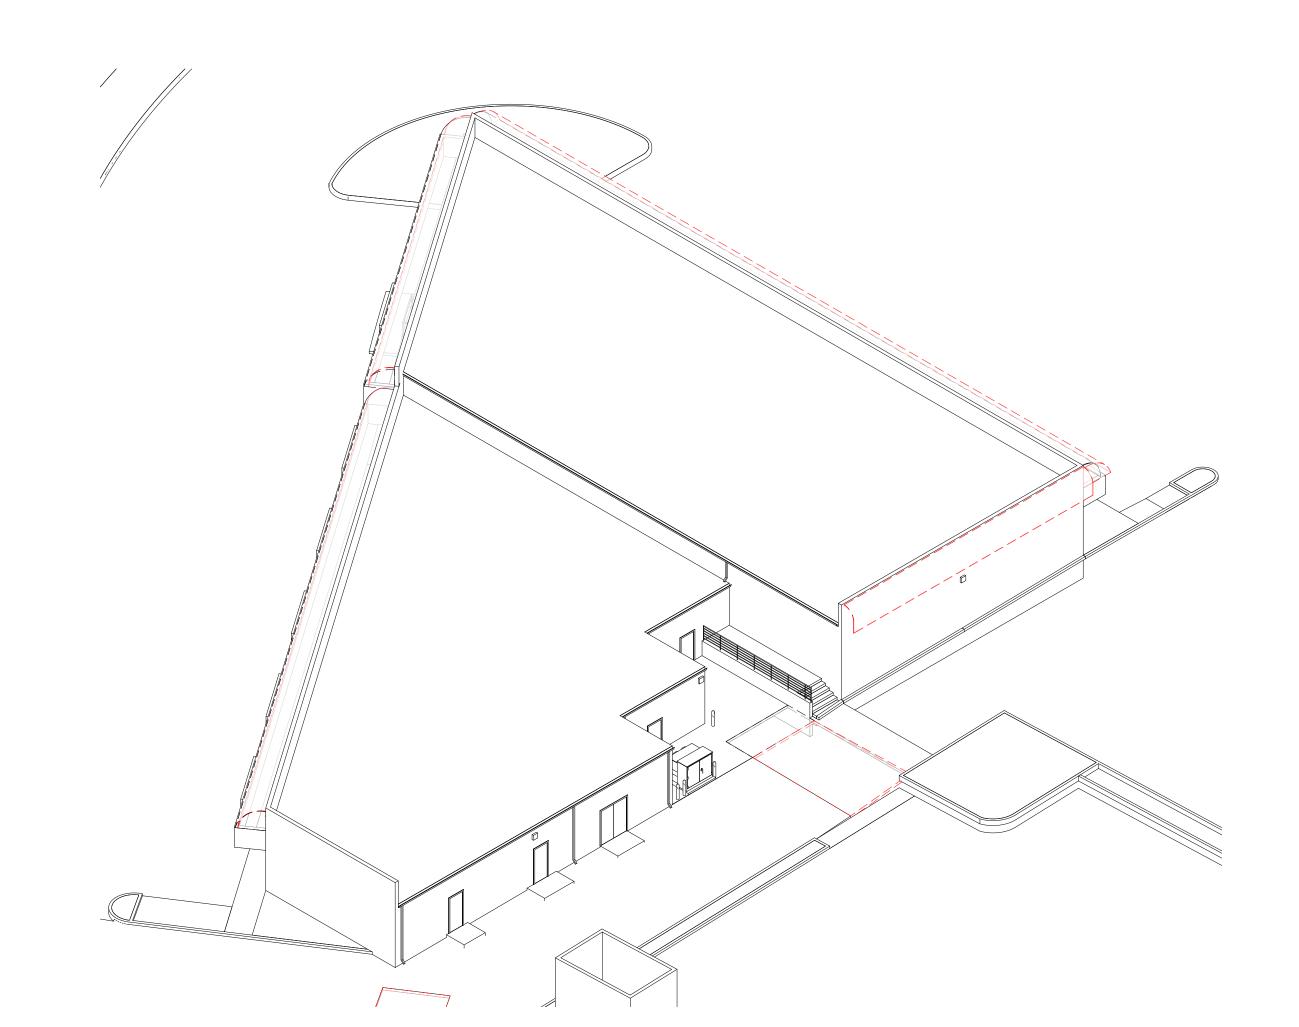

AXO VIEW - SW

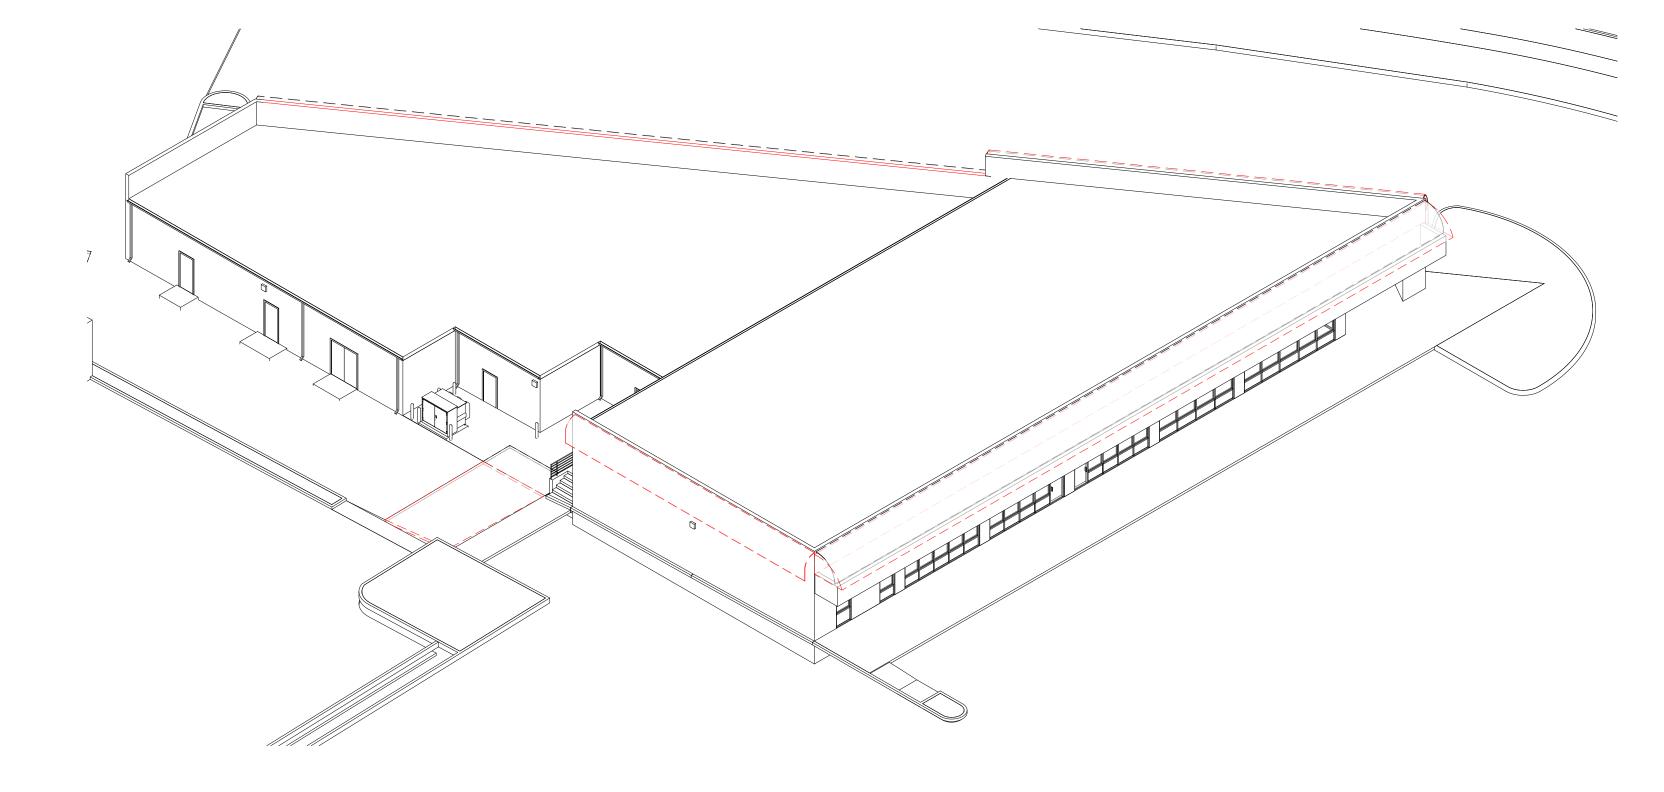

AXO VIEW - SE

SHEET TITLE
DEMO AXO VIEWS

ARCH 1010

676 Marshall Ave. Suite 101 Memphis, TN 38103 901.497.6563 www.arch1010.com

CONSULTANT / SEAL

PROJECT NAME

BARTLETT SHOPPING CENTER

6001 BARTLETT CENTER DRIVE, BARTLETT TN

PROJECT NUMBER


DEVELOPER/OWNER

MR. MARTIN CHOW

PROJECT LOGO

05.12.2025
SHEET NUMBER

D0.0

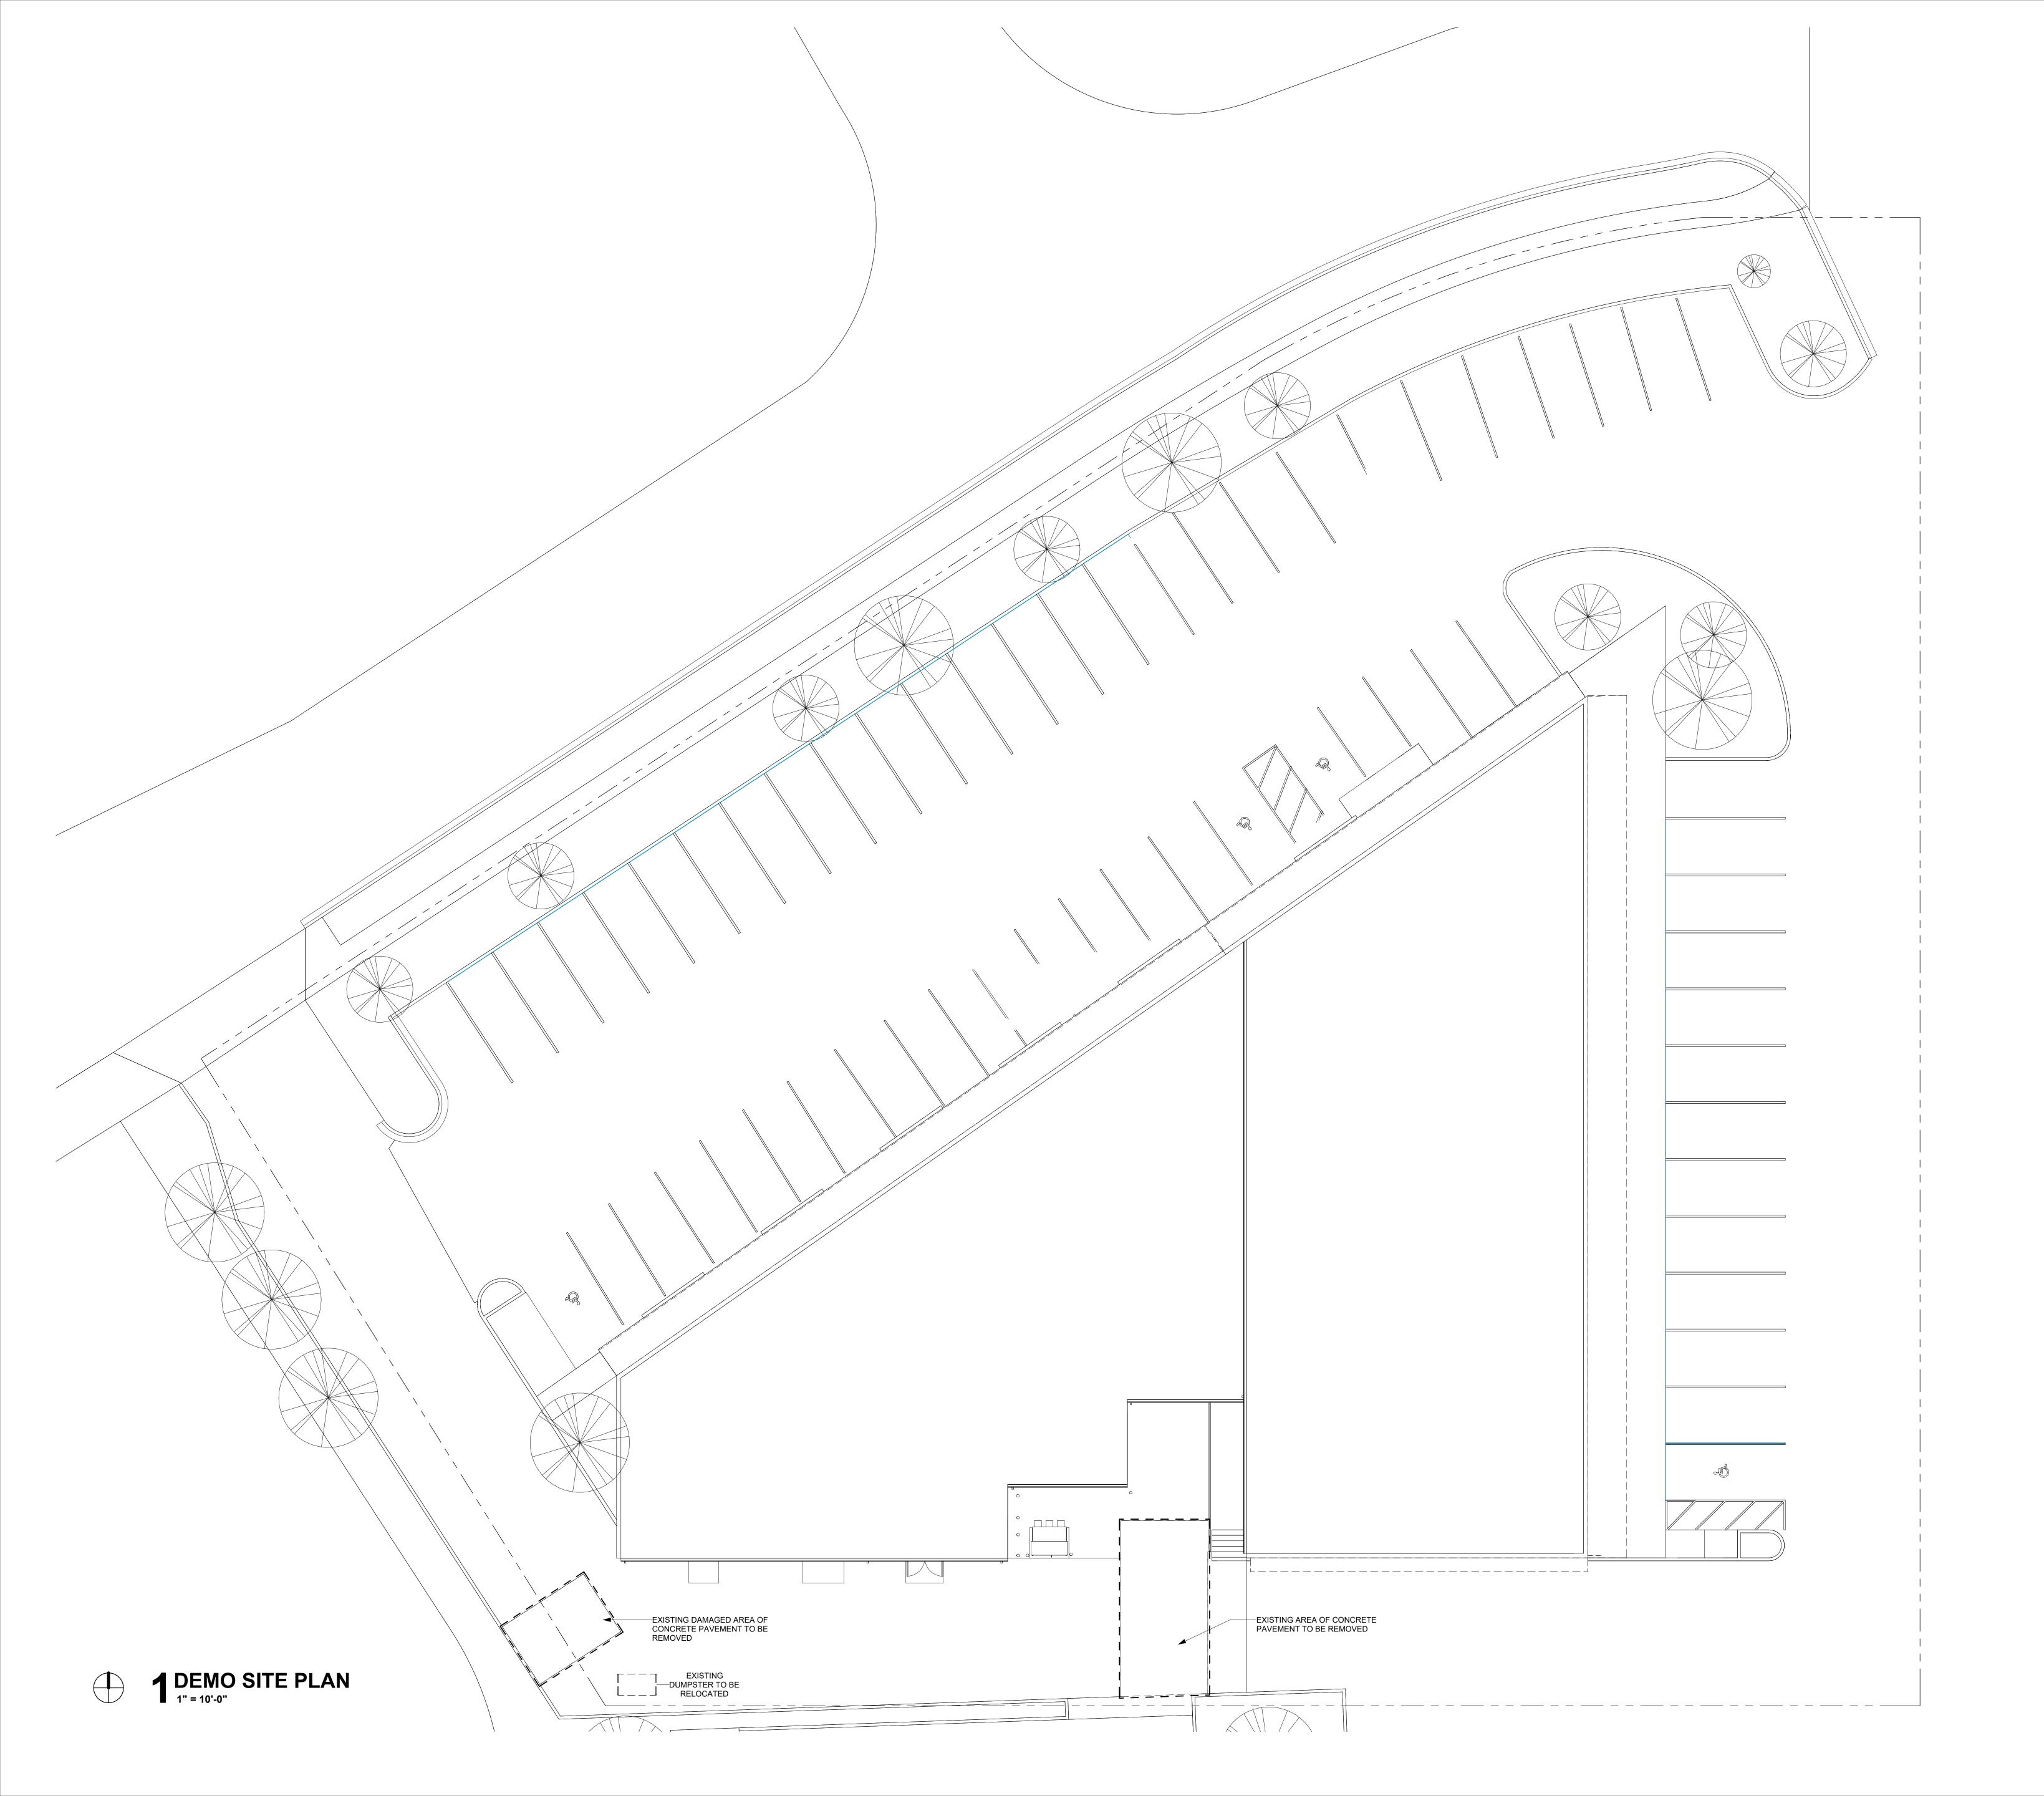

676 Marshall Ave. Suite 101 Memphis, TN 38103 901.497.6563 www.arch1010.com CONSULTANT / SEAL

PROJECT NAME BARTLETT SHOPPING CENTER

LOCATION

6001 BARTLETT CENTER DRIVE, BARTLETT TN

PROJECT NUMBER


DEVELOPER/OWNER MR. MARTIN CHOW

PROJECT LOGO

SHEET TITLE DEMO SITE PLAN

05.12.2025

SHEET NUMBER

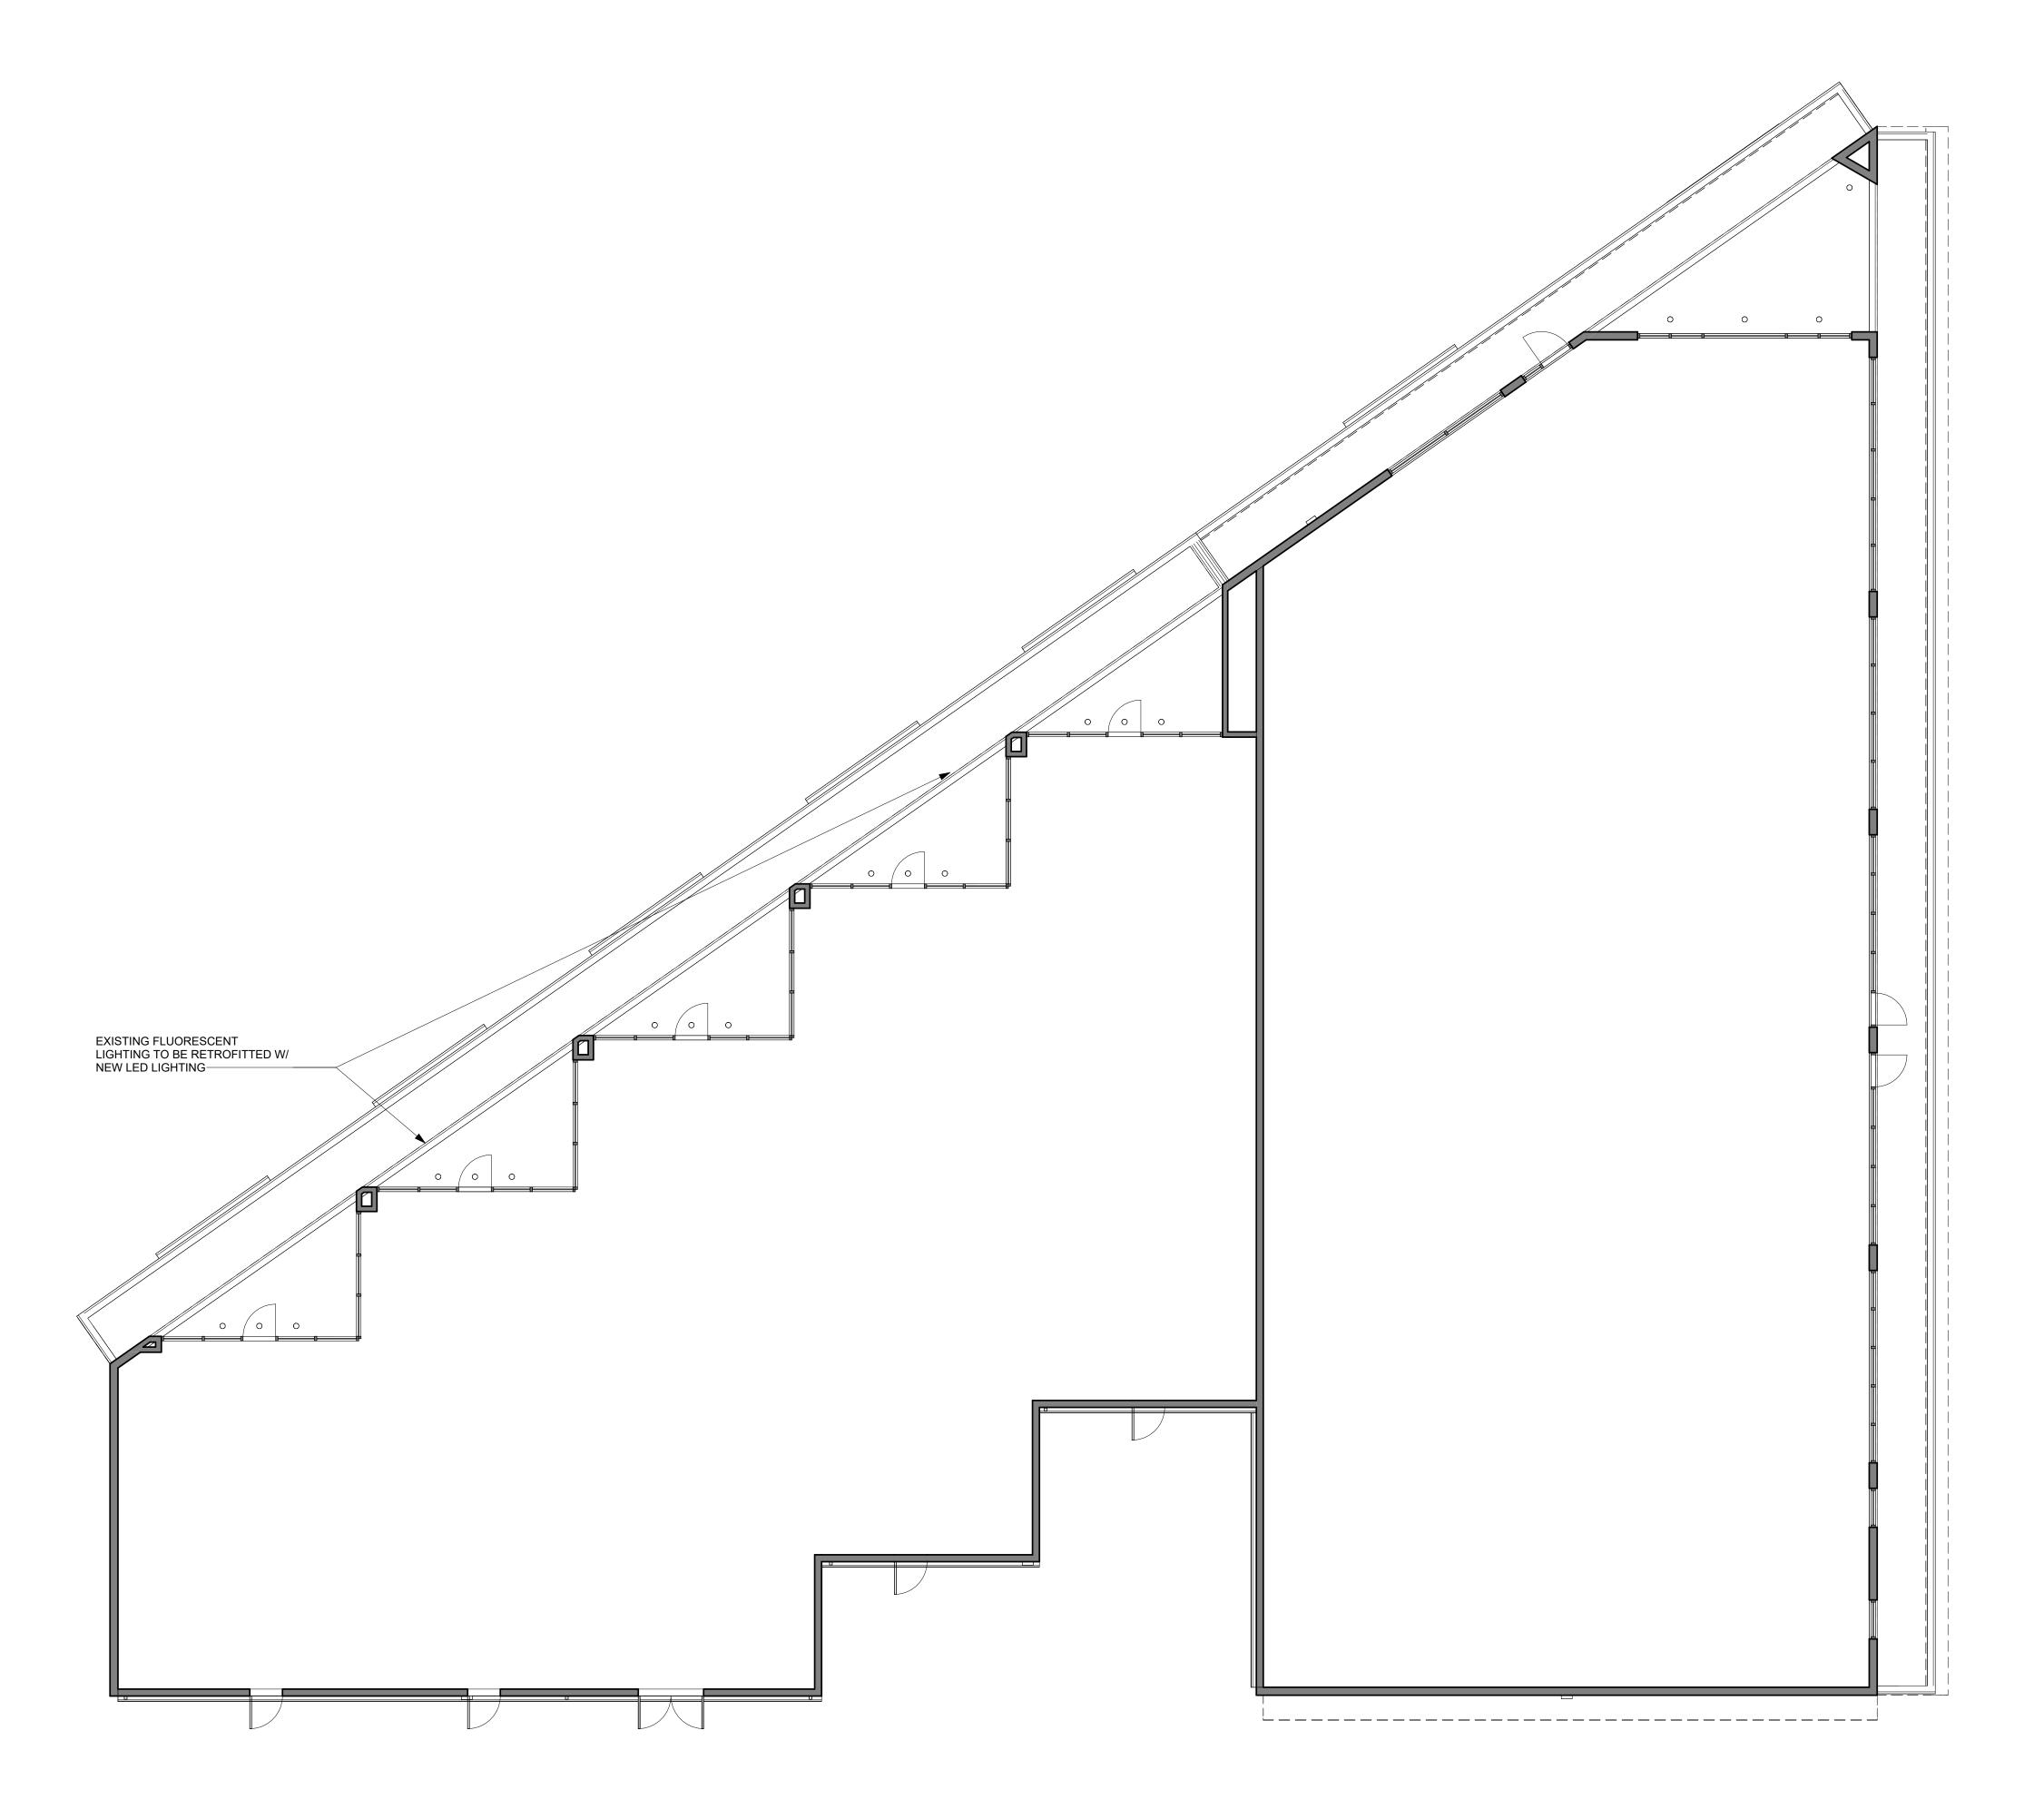

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PROJECT NAME BARTLETT SHOPPING CENTER

A-00000

LOCATION

6001 BARTLETT CENTER DRIVE, BARTLETT TN **PROJECT NUMBER**

DEVELOPER/OWNER MR. MARTIN CHOW


PROJECT LOGO

INFORMATION **ISSUE DATE**


REVISION

SHEET TITLE
DEMO RCP


DATE 05.12.2025 SHEET NUMBER

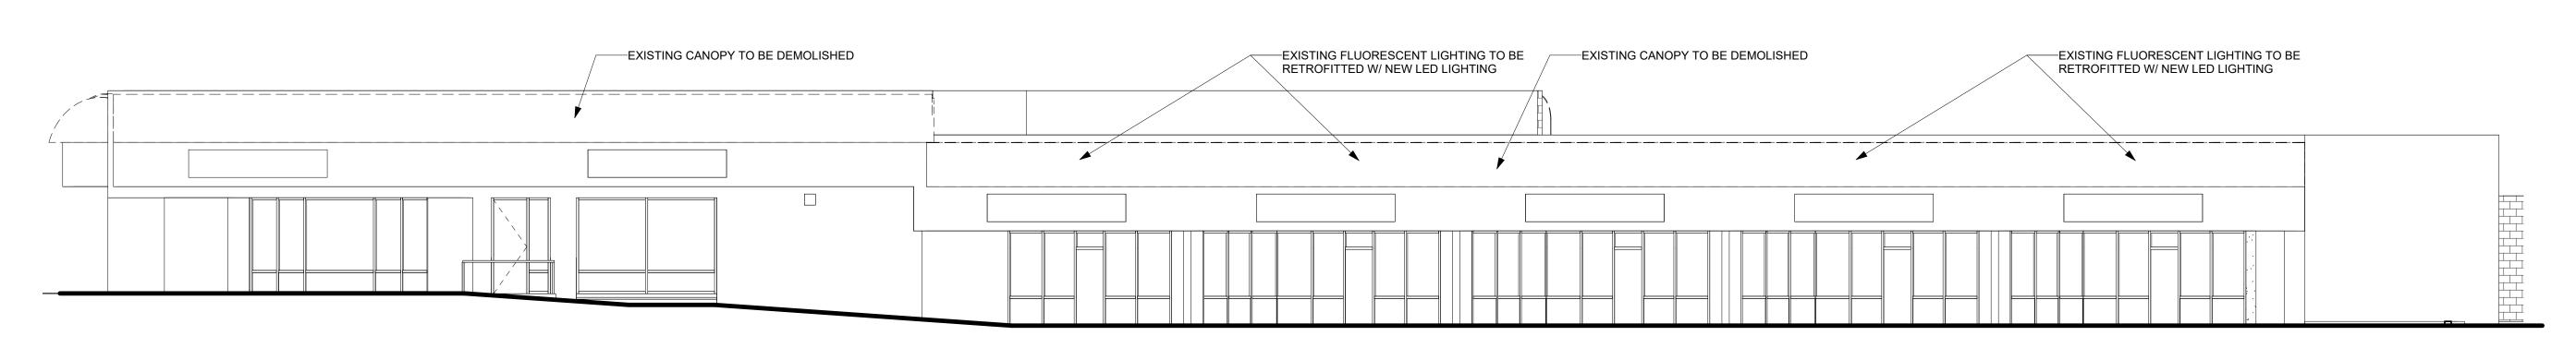


1 DEMO NORTH ELEVATION 1/8" = 1'-0"

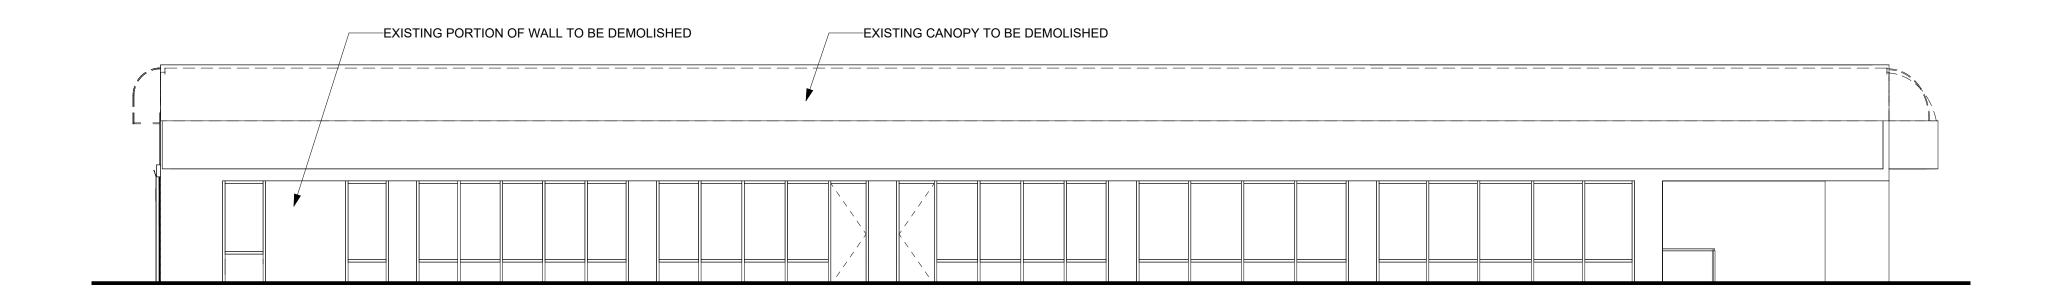

2 DEMO EAST ELEVATION 1/8" = 1'-0"

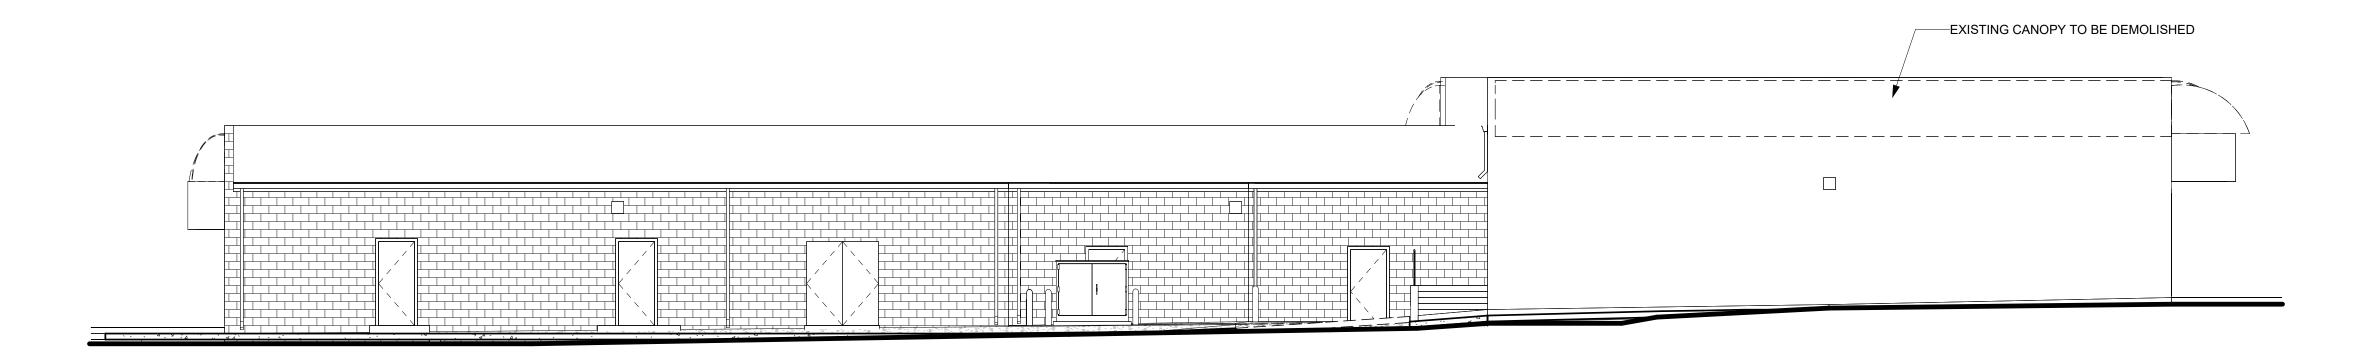

3 DEMO SOUTH ELEVATION

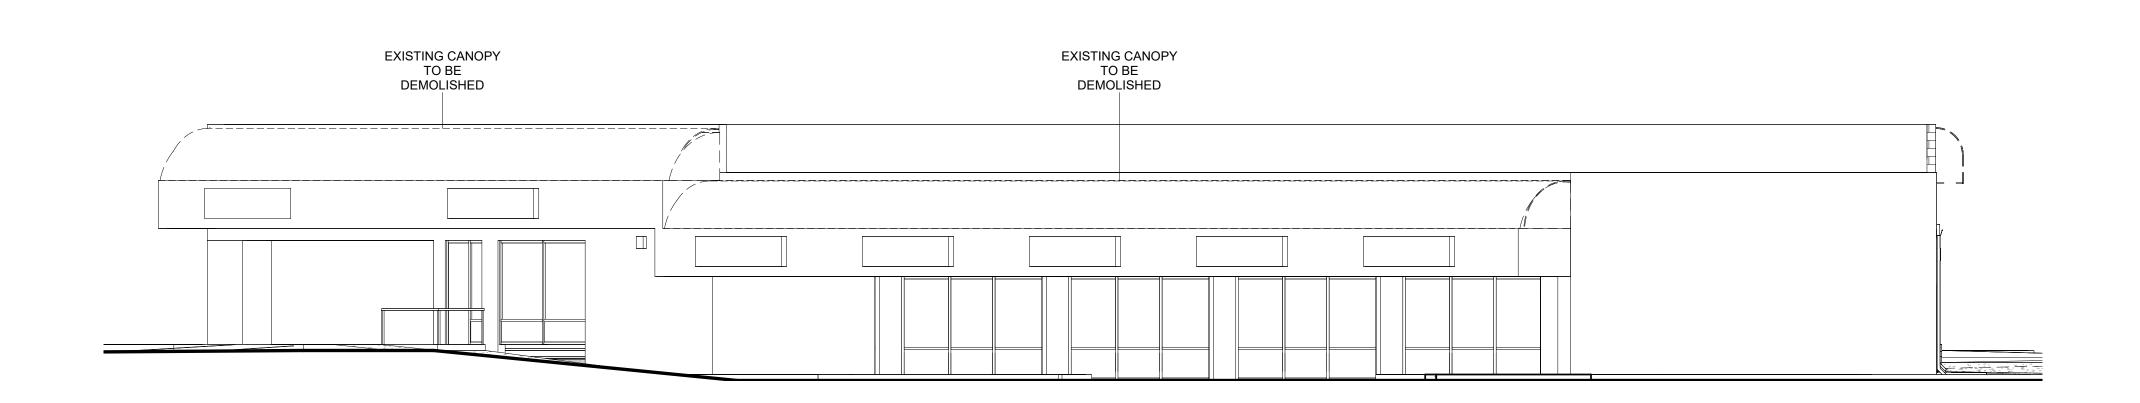

4 DEMO WEST ELEVATION

1/8" = 1'-0"

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PROJECT NAME

BARTLETT SHOPPING
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6001 BARTLETT CENTER
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MR. MARTIN CHOW

PROJECT LOGO


INFORMATION
REVISION ISS

SHEET TITLE
DEMO ELEVATIONS

05.12.2025

SHEET NUMBER

D3.0

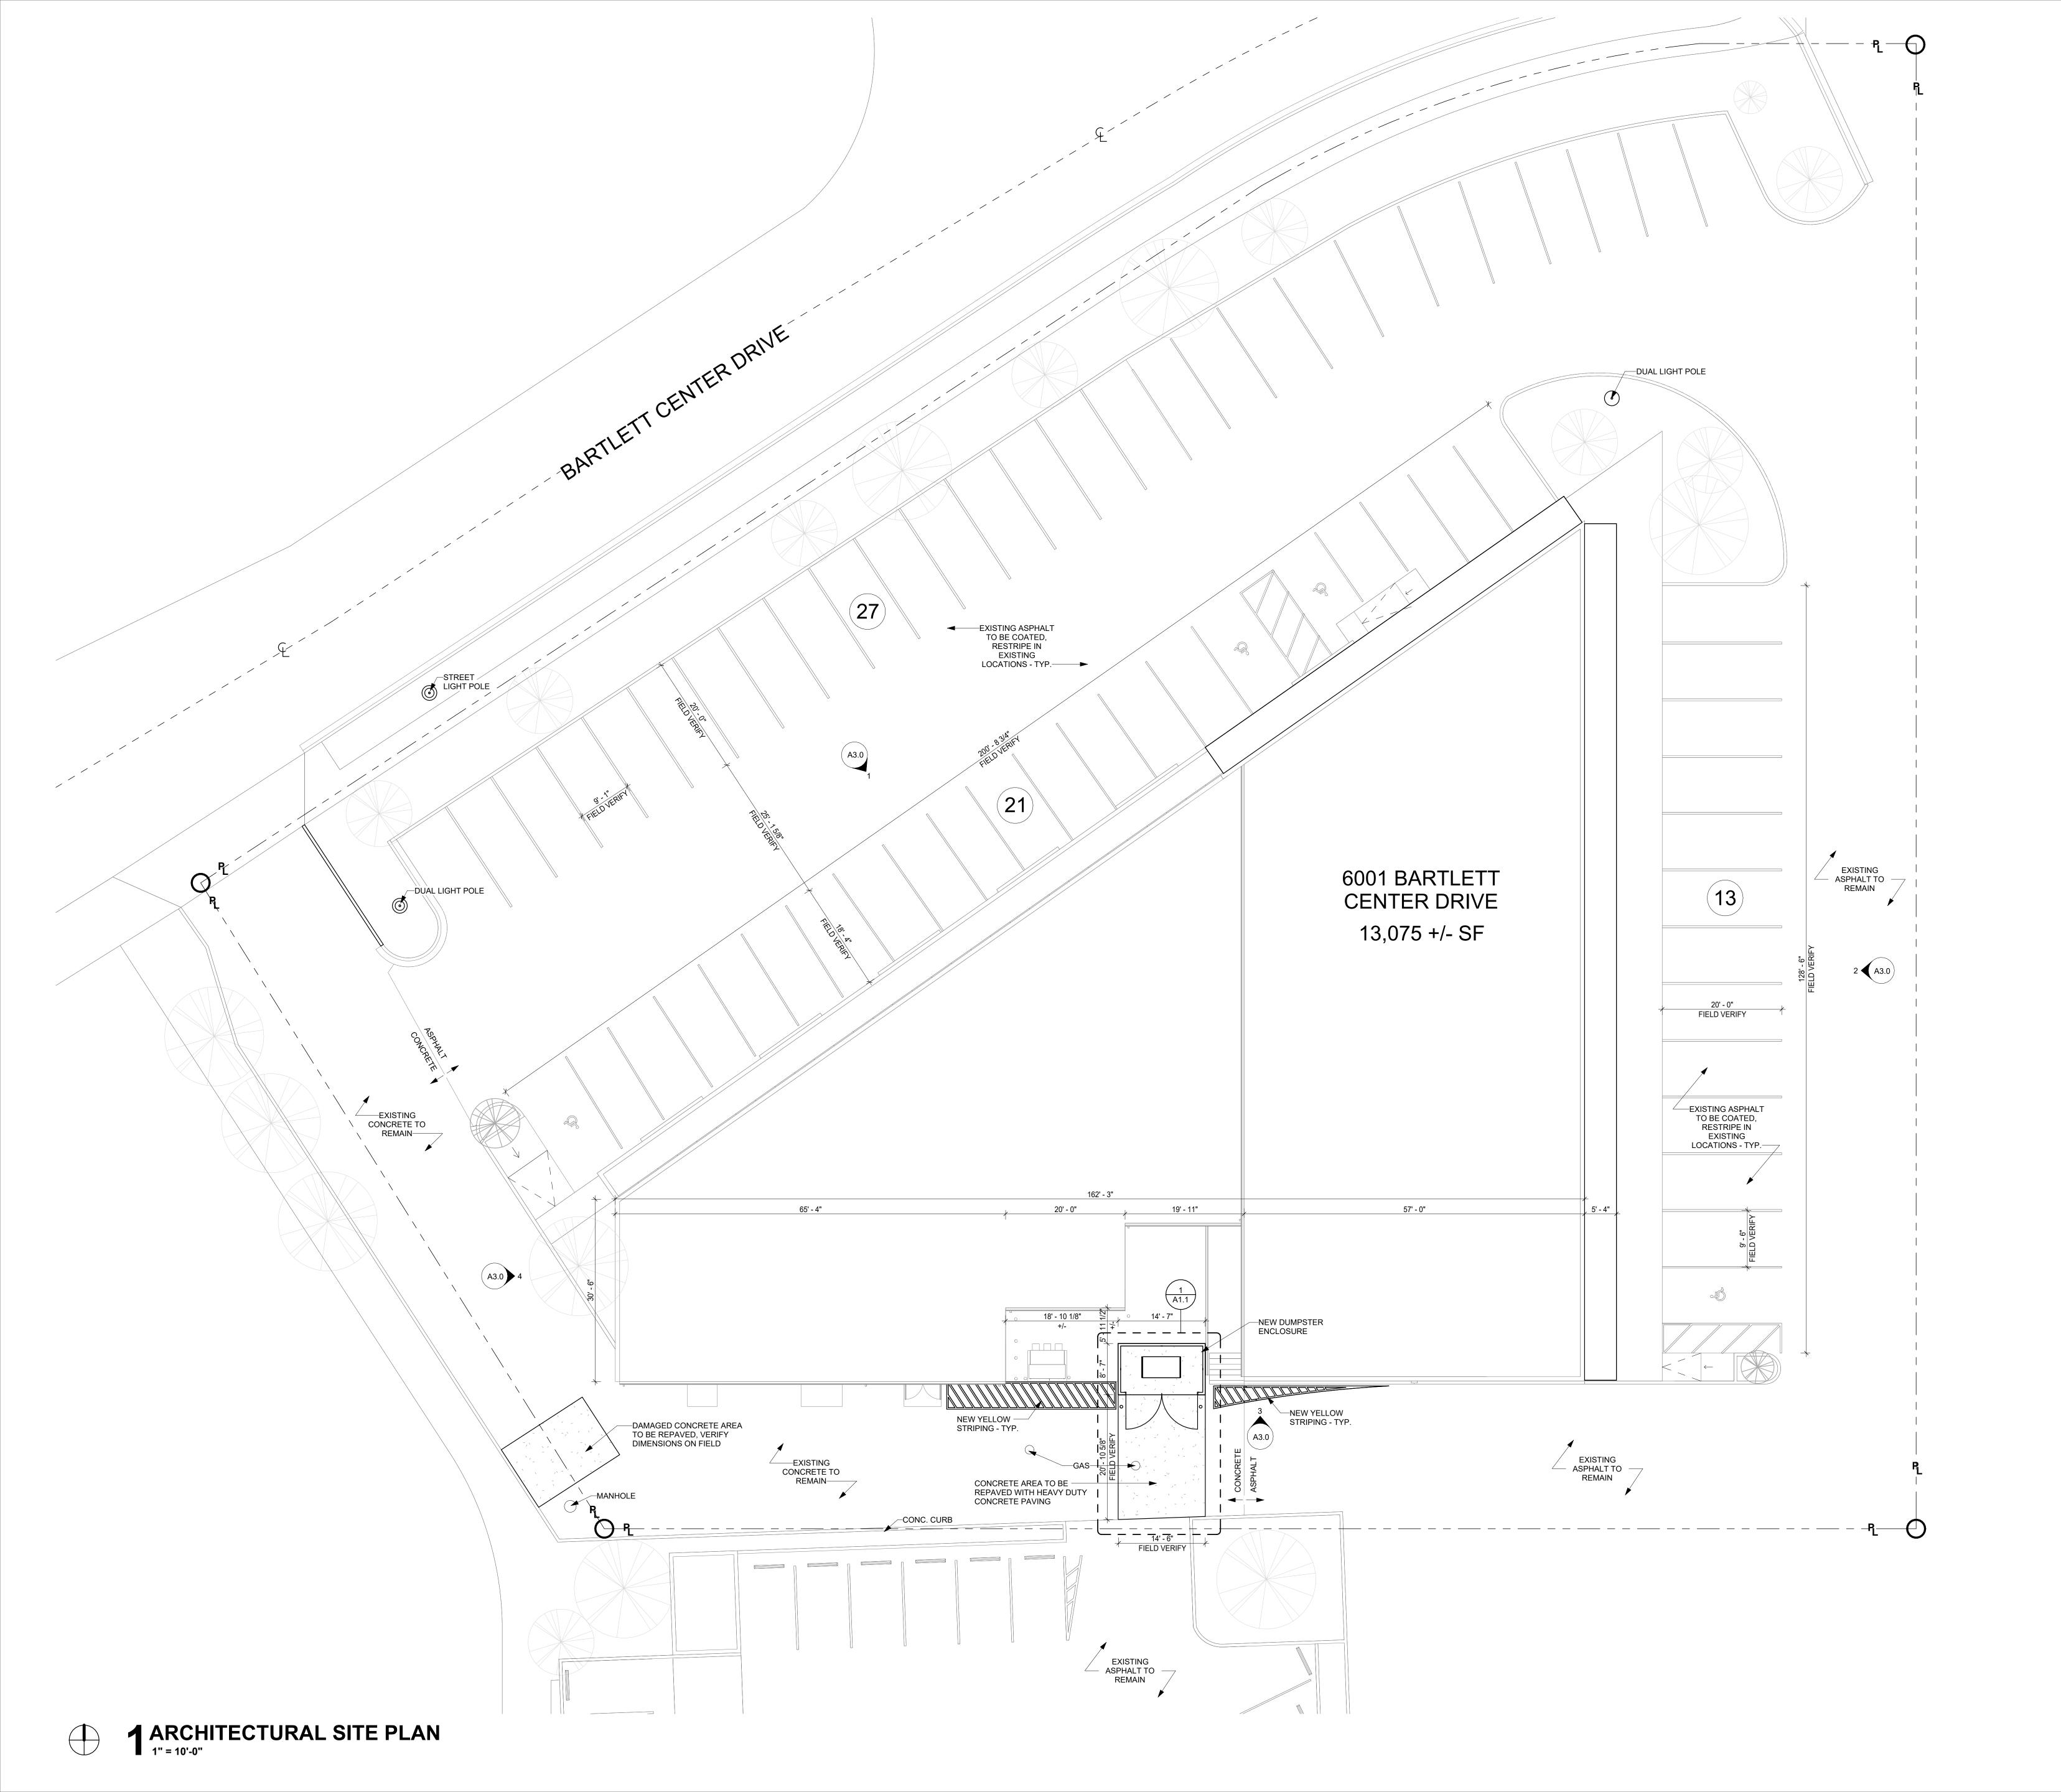

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MR. MARTIN CHOW

PROJECT LOGO

NFORMATION


REVISION ISSUE DA

SHEET TITLE
ARCHITECTURAL SITE
PLAN

05.12.2025

SHEET NUMBER

A1 0

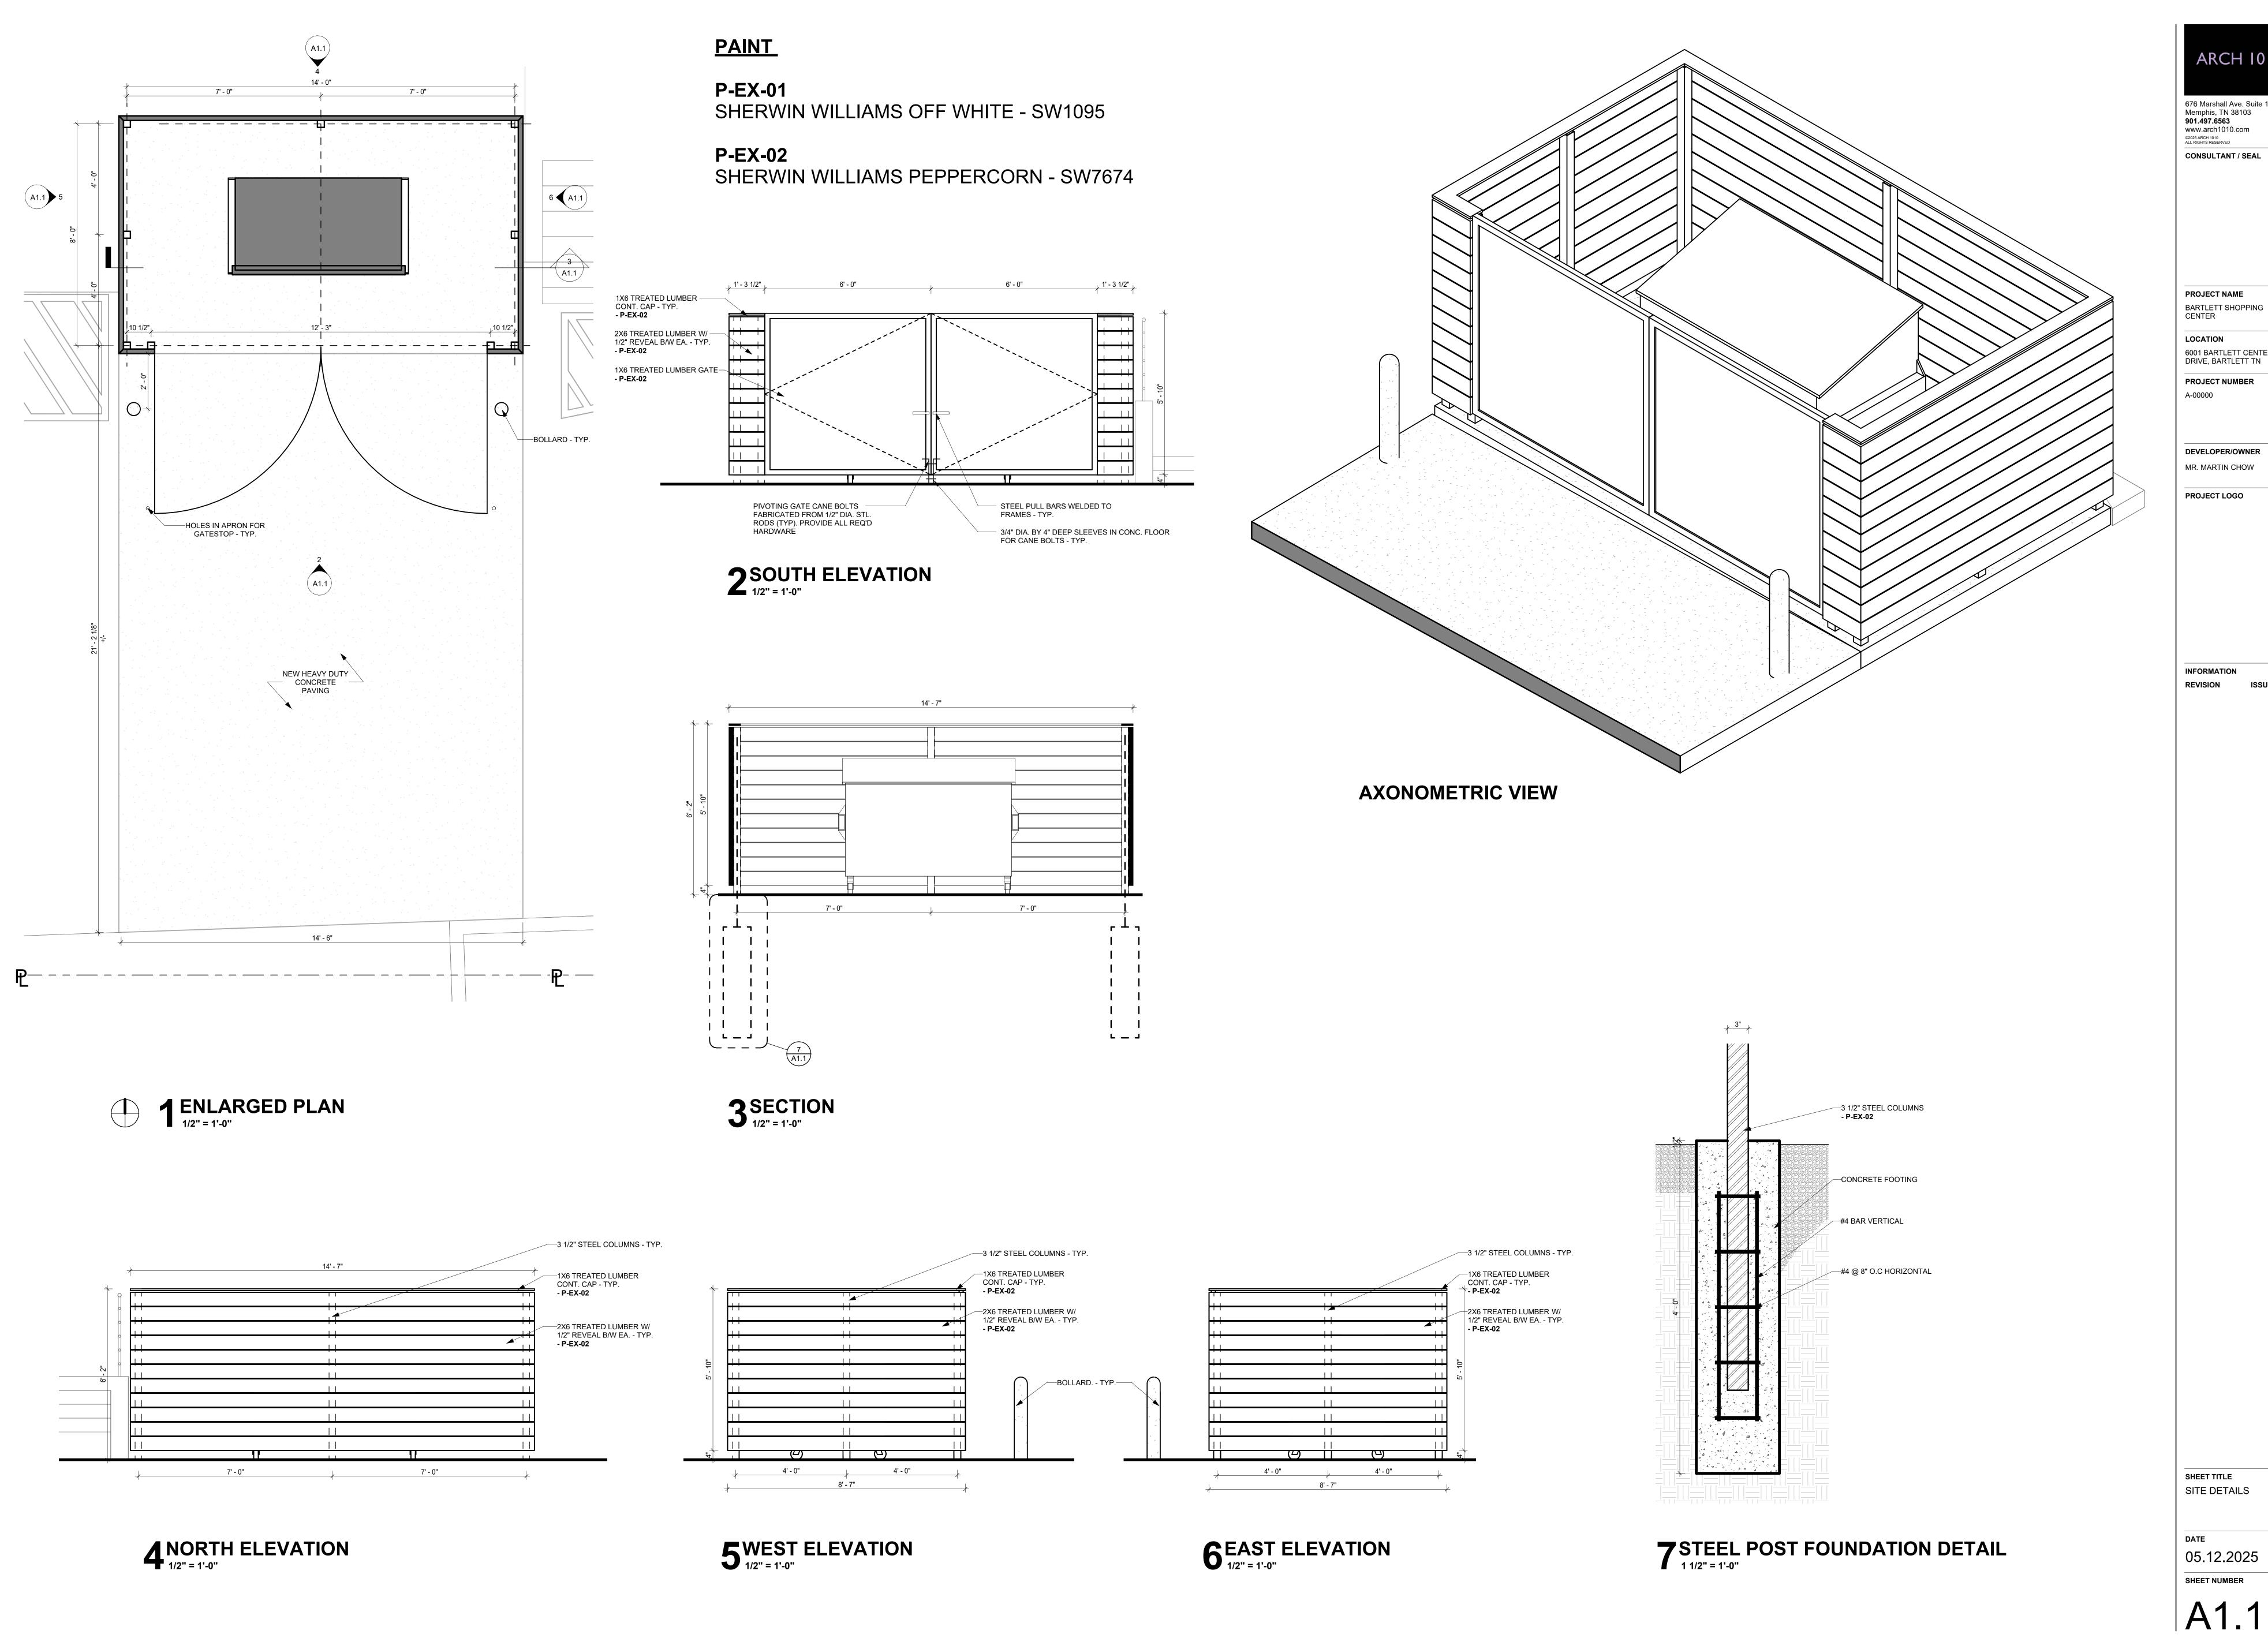


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PROJECT NAME

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INFORMATION

REVISION


SHEET TITLE
FLOOR PLAN

05.12.2025

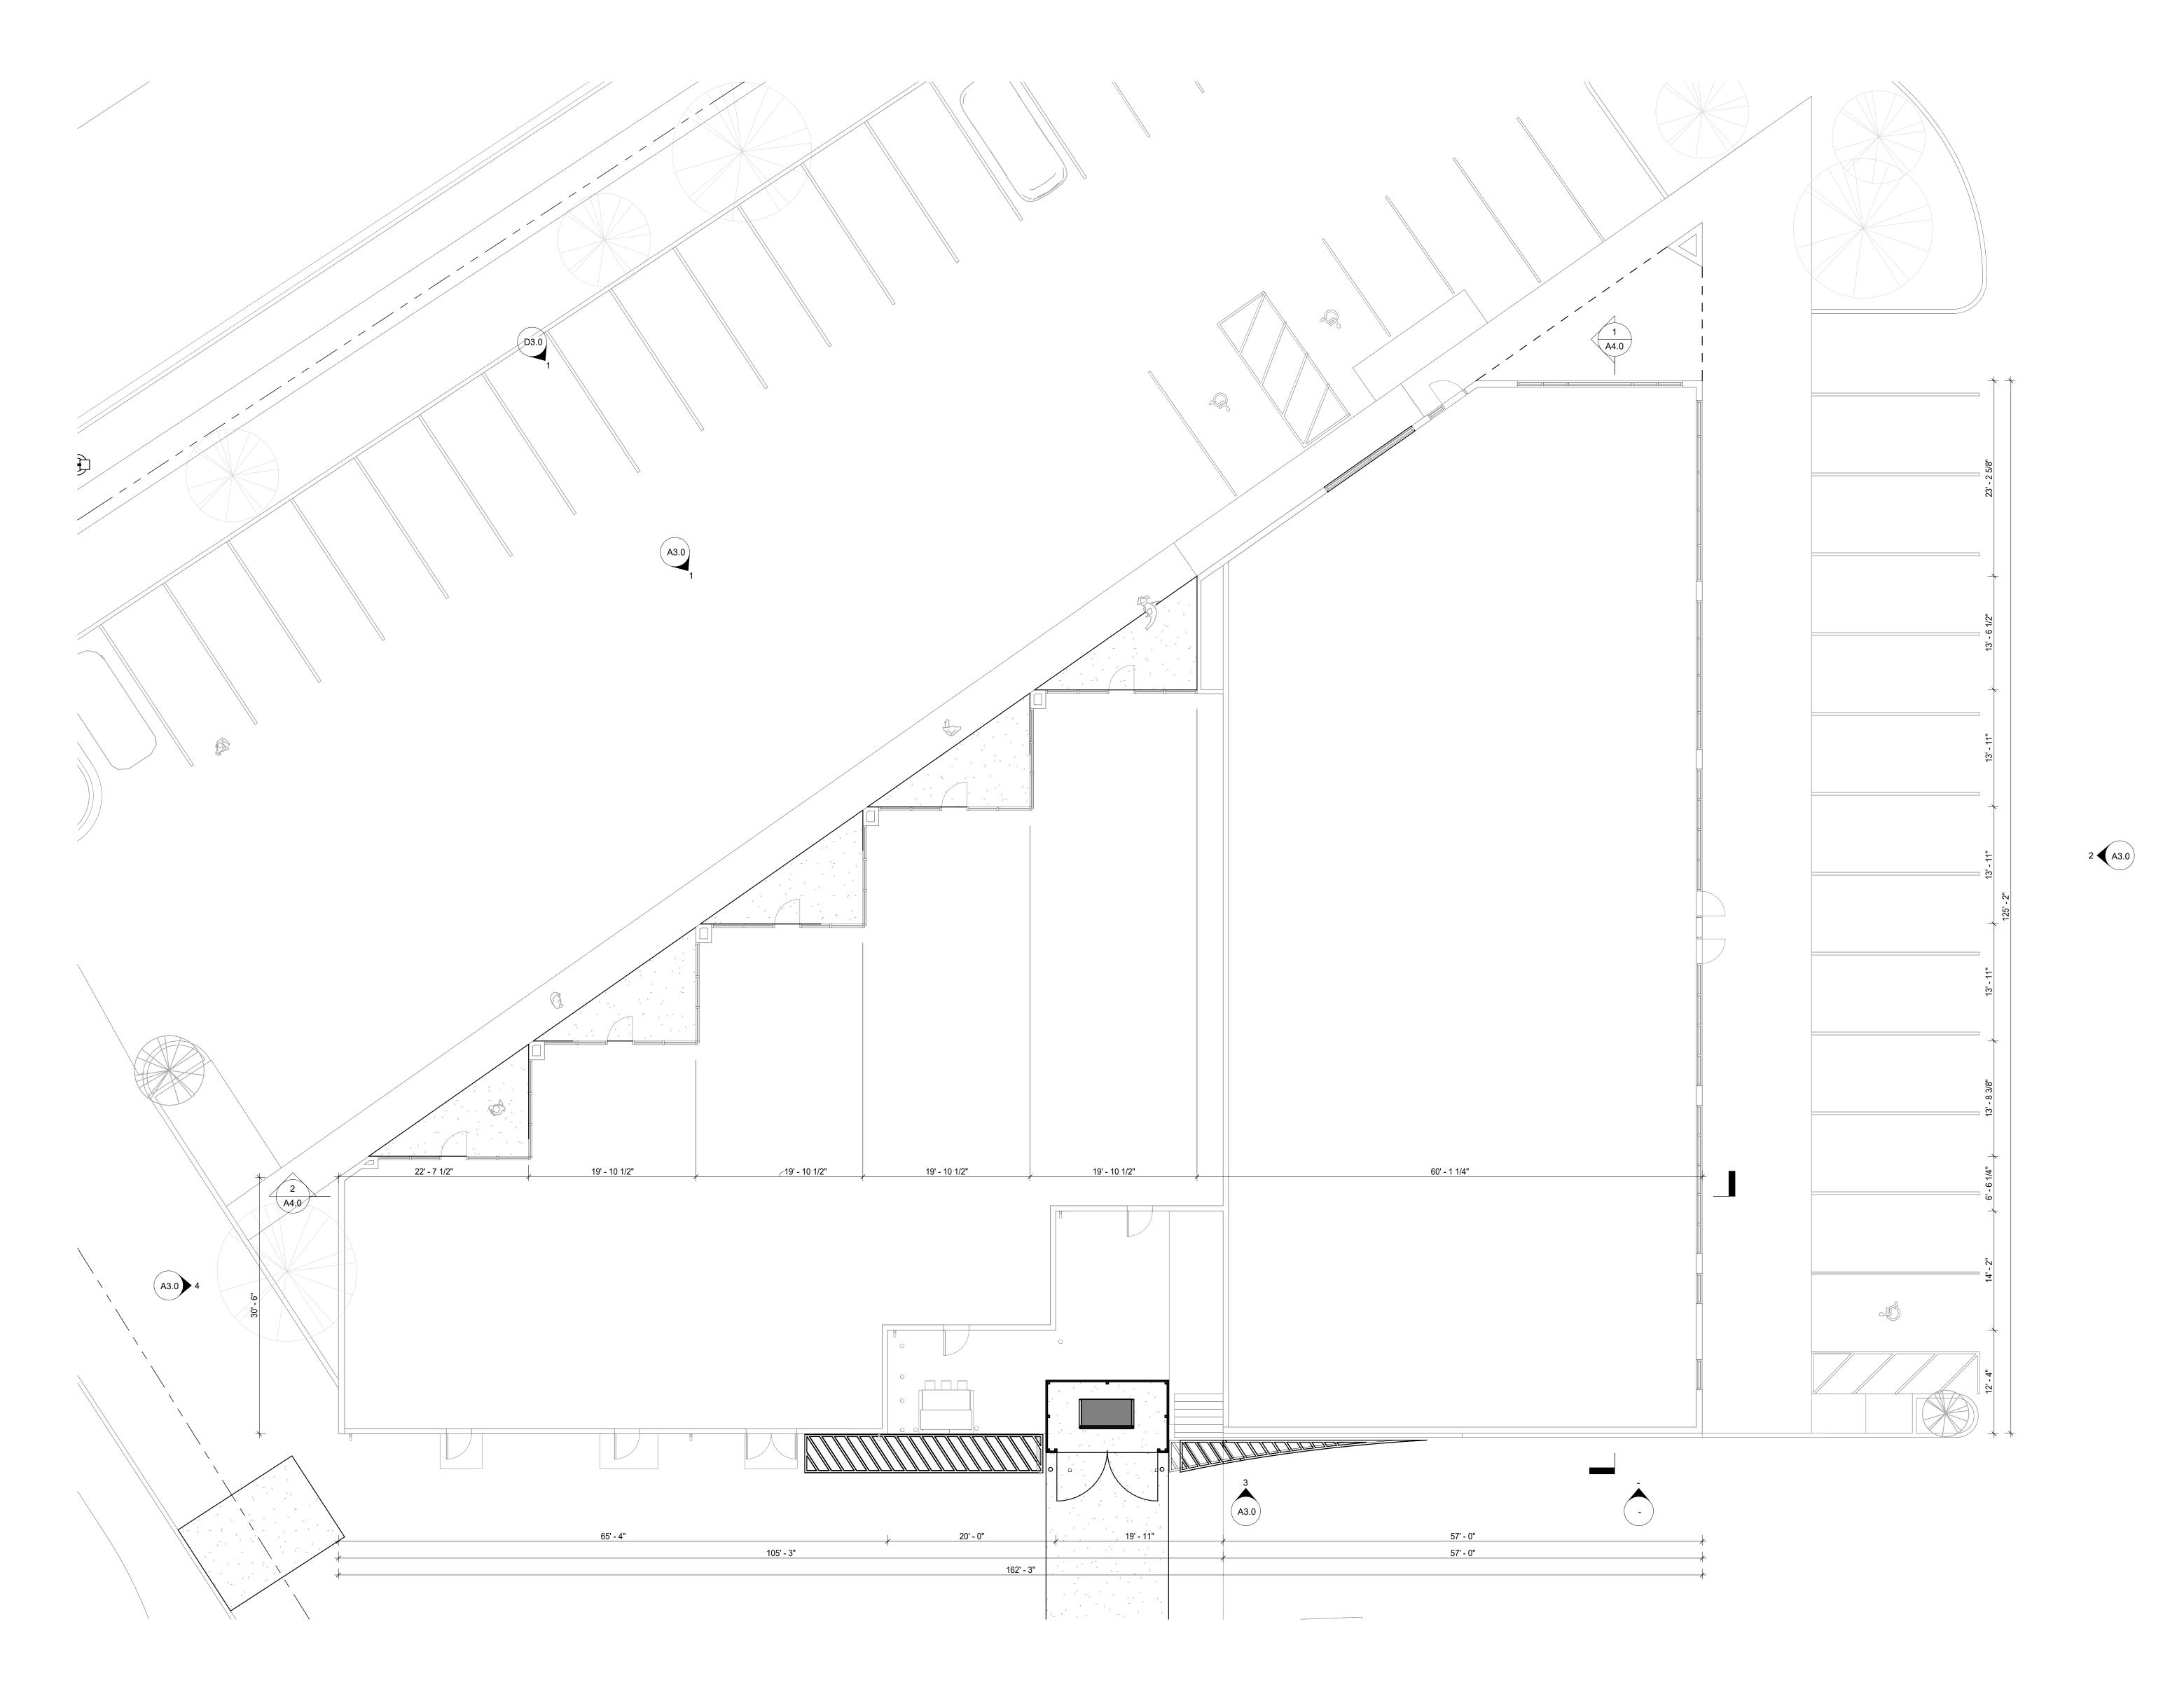SHEET NUMBER

A2.0

1 FLOOR PLAN1/8" = 1'-0"

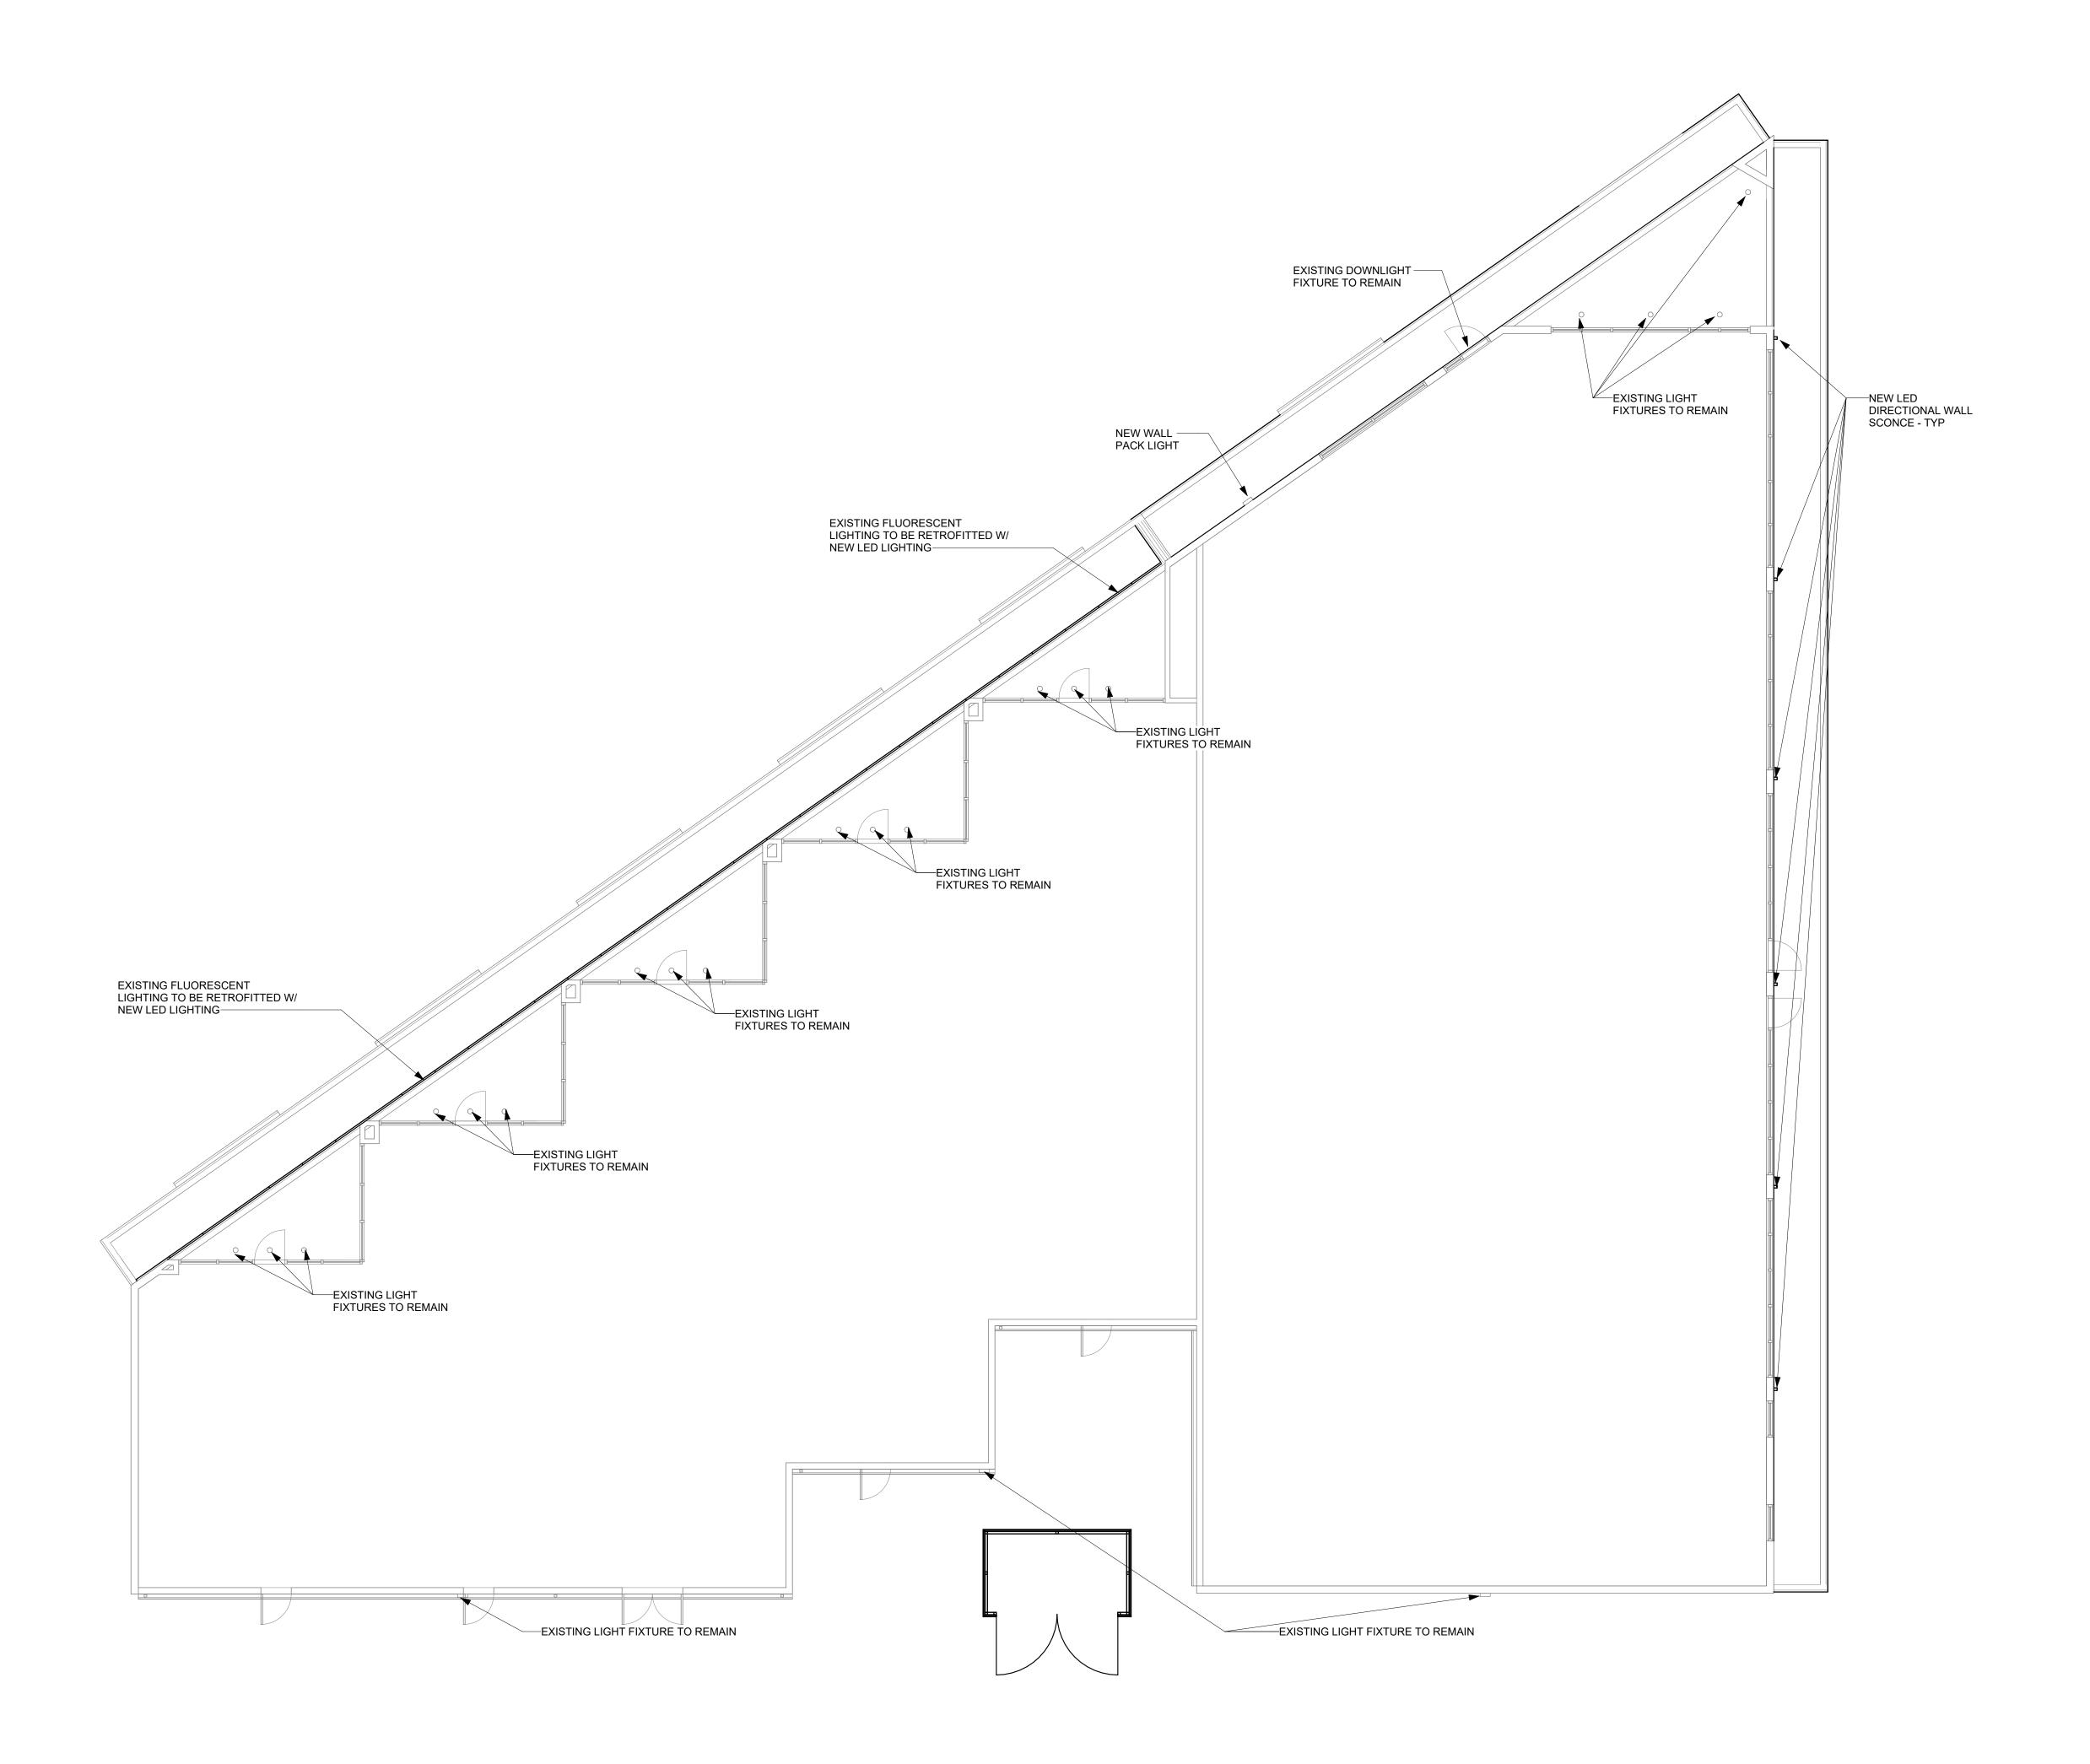

1 REFLECTED CEILING PLAN
1/8" = 1'-0"

GENERAL NOTES

- REFER TO GENERAL NOTES SHEET G0.1 FOR ADDITIONAL INFORMATION.
- REFER TO ELECTRICAL ENGINEERING DWGS FOR LIGHT FIXTURE SPECS.
- ALL GWB HEADER/ BULK HEAD TO BE PAINTED COLOR TBD
 CENTER ALL DEVICES ON CEILING TILE UNLESS NOTED OTHERWISE.
- CENTER ALL CEILING TILE SYSTEM IN ROOM UNLESS NOTED OTHERWISE.
- AT ALL PAINTED CEILINGS: PAINT ALL EXPOSED CEILINGS, DUCTWORK, DEVICES, AND EQUIPMENT.
- ALL CEILING TO BE XX'-XX" A.F.F. UNLESS NOTED OTHERWISE

CEILING TYPE LEGEND

- A. REFER TO ELECTRICAL AND MECANICAL DRAWINGS. REPORT ANY DISCREPANCY TO THE ARCHITECT. CONTRACTOR TO USE THIS SHEET FOR ALL DEVICE & FIXTURE LOCATIONS
- B. <u>ALL</u> CEILING COMPONENTS INCLUDING PERIMETER TRIM, TRANSITIONS, ETC. TO BE PART OF CEILING MANUFACTURER SYSTEM UNLESS APPROVED BY ARCHITECTURE.
- C. REFER TO FINISH PLAN FOR PAINT COLOR LOCATIONS. REPORT ANY DISCREPANCY TO THE ARCHITECT.
- D. SUSPENDED CEILING HEIGHT TO BE AS NOTED ON REFLECTED CEILING PLAN
- WALLS TO EXTEND 12" MINIMUM ABOVE CEILING U.N.O.
 FIRE RATED AND OR SOUND INSULATED WALLS TO EXTEND TO BOTTOM OF
 ROOF DECK U.N.O. REFER TO WALL SCHEDULE AND BUIDING SECTIONS.

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PROJECT NAME
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CENTER

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LOCATION
6001 BARTLETT CENTER

DRIVE, BARTLETT TN
PROJECT NUMBER

DEVELOPER/OWNER

MR. MARTIN CHOW

PROJECT LOGO


INFORMATION
REVISION ISSUE DATE

REFLECTED CEILING
PLAN


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05.12.2025
SHEET NUMBER


Δ2 2

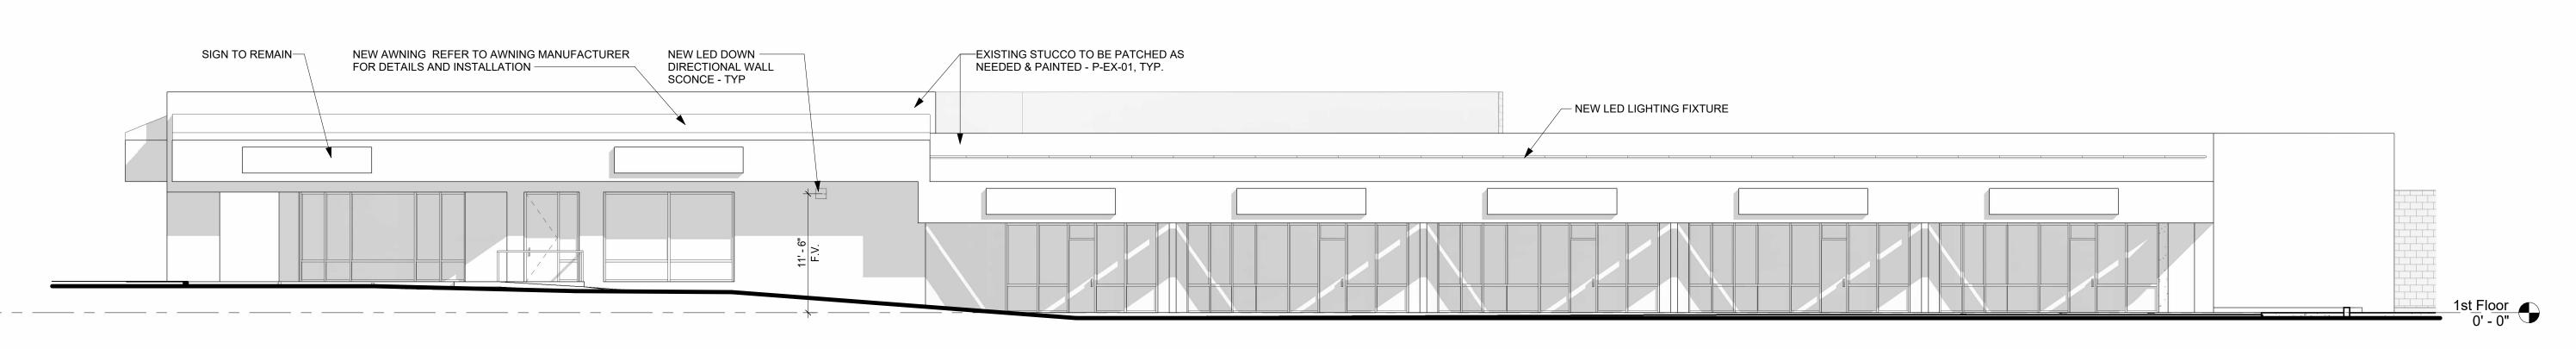


1 NORTH ELEVATION 1/8" = 1'-0"

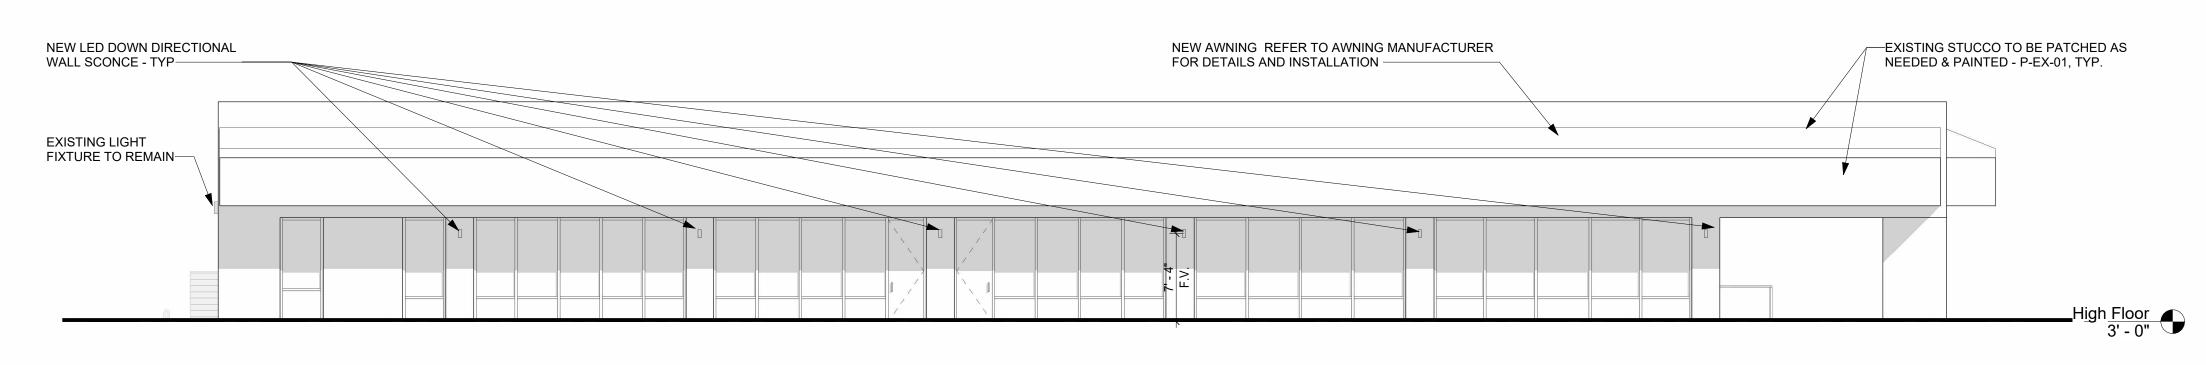

2 EAST ELEVATION 1/8" = 1'-0"

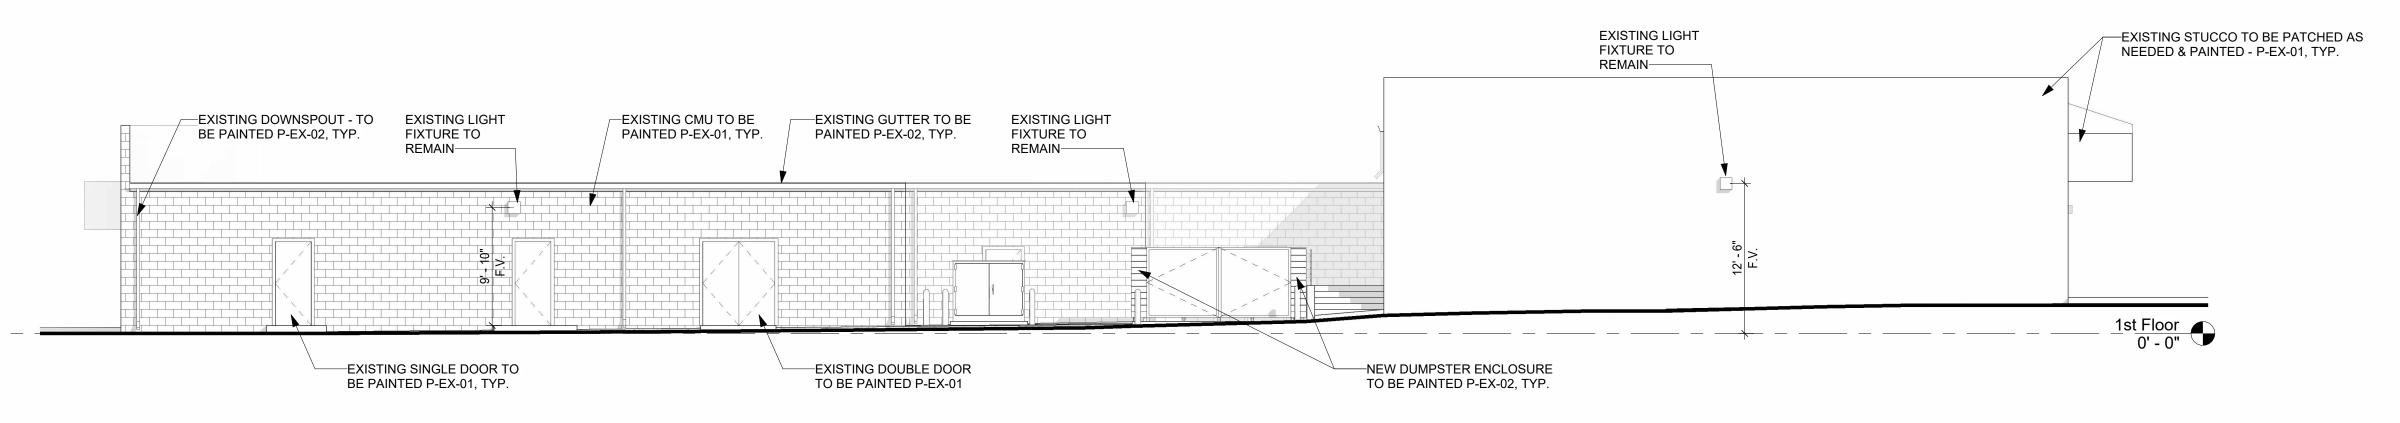

3 SOUTH ELEVATION

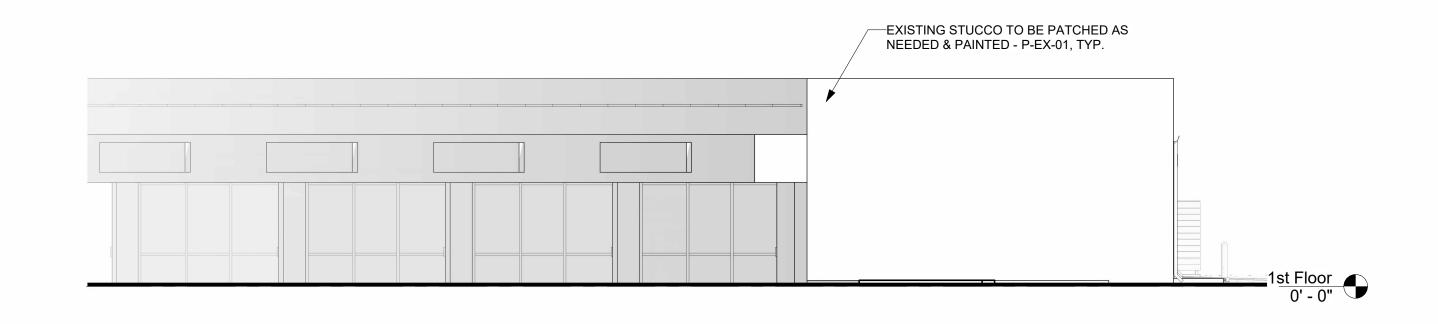



GENERAL NOTES

1. EXISTING EIFS TO BE PATCHED AND REPAIRED WHEN NEEDED

PAINT LEGEND

P-EX-01 SHERWIN WILLIAMS OFF WHITE - SW1095

P-EX-02 SHERWIN WILLIAMS PEPPERCORN - SW7674

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DEVELOPER/OWNER MR. MARTIN CHOW

PROJECT LOGO

INFORMATION REVISION


ISSUE DATE


EXTERIOR ELEVATIONS


05.12.2025

SHEET NUMBER

A3.0

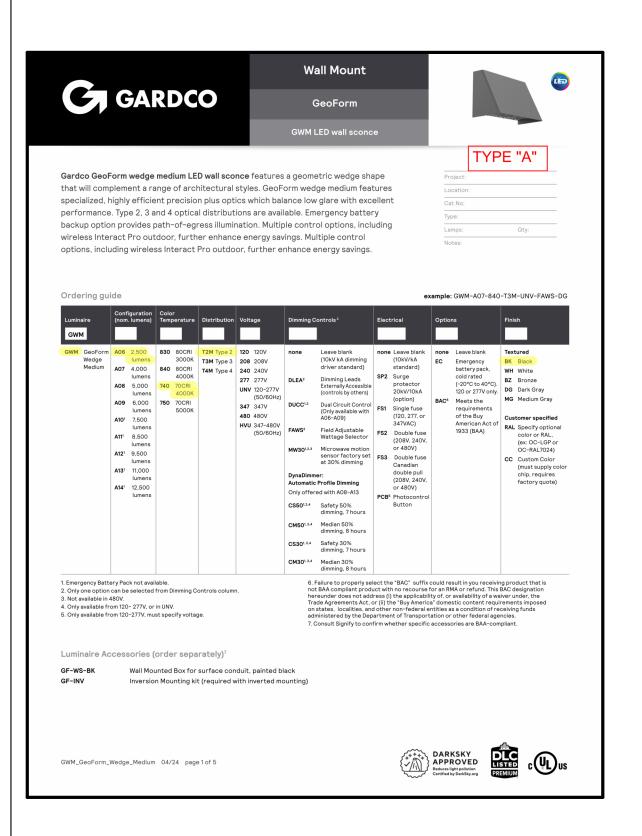

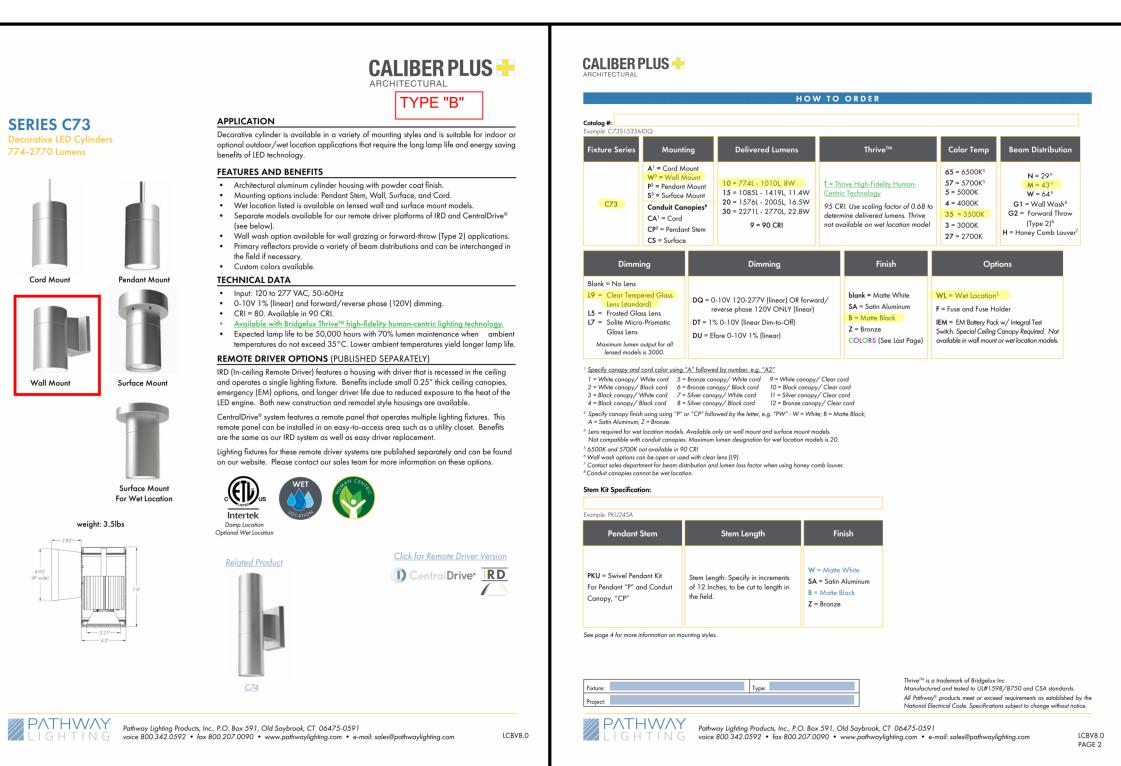

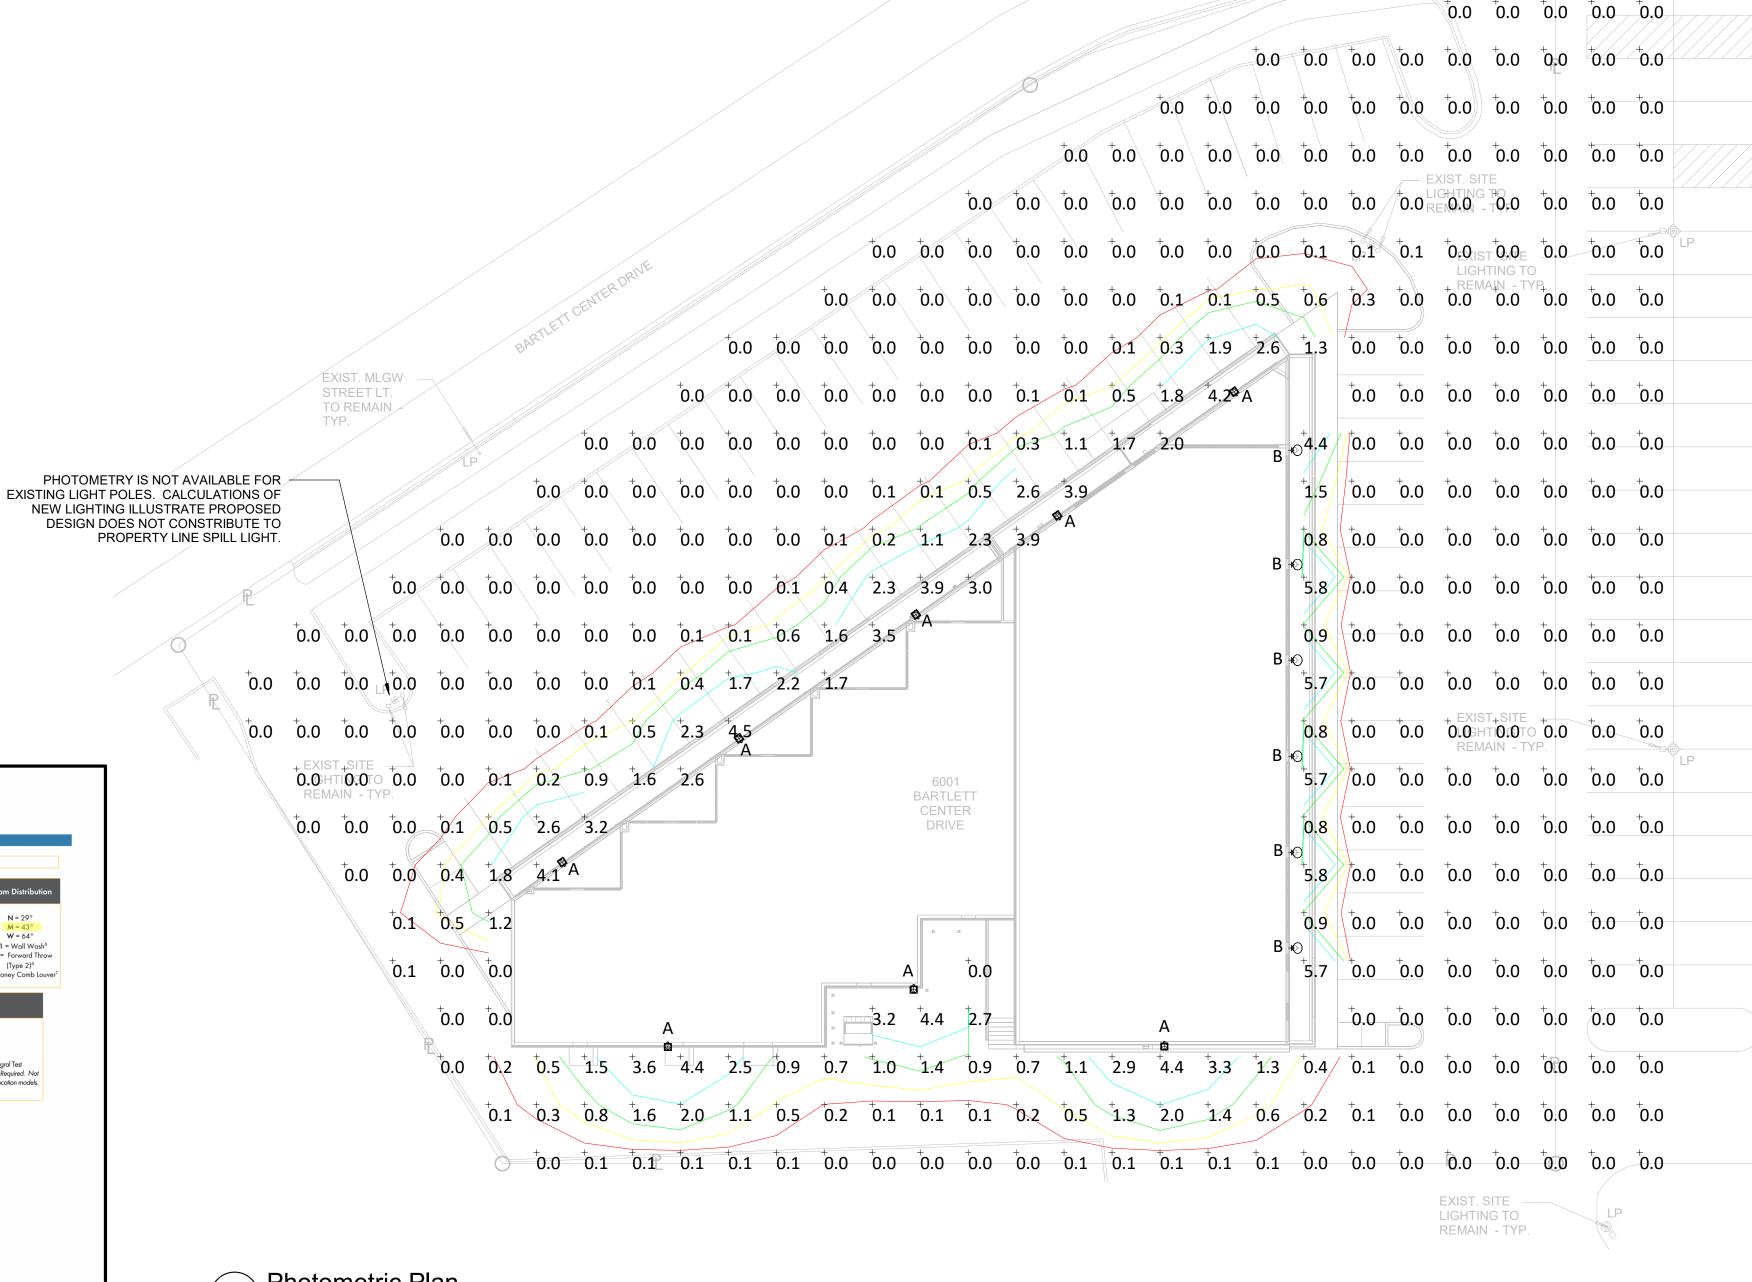

LT. TO REMAIN - TYP.

	Photometric Pla
E100	1" = 20'-0"

Calculation Summary							
Label	CalcType	Units	Avg	Max	Min	Max/Min	
East Side	Illuminance	Fc	3.23	5.8	0.8	7.25	
North Side	Illuminance	Fc	3.38	4.5	1.7	2.65	

Luminaire Schedule							
Symbol	Qty	Tag	Mounting Height	Lum. Lumens	Lum. Watts	LLF	Description
4	8	Α	10	2928	16.3	0.900	GWM-A06-740-T2M
#	6	В	7	1006	7.8	0.900	C73LB78V1035KM



RENOVATION TO BARTLETT CENTE!

MR. MARTIN CHOW

6001 BARTLETT CENTER DRIVE, BARTLETT TN

OF TENNSON



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Joshua N. Bellaire

Revisions

Number Date Description

PROJECT # 21032

DATE:12/13/2024

DRAWN BY: dpw

Photometric Plan

E100



PRODUCT DESCRIPTION

Tucana III adds 0-10v dimmability, top level DLC 5.1 Premium certification, with an Ultra-Efficient 140+ lumens per watt and Dark Sky Compliance, and a new clean design that hides any screws from visibility







DLC #:

RGL-TUCANA-3-TT-40W

PRODUCT FEATURES & COMMON USE APPLICATIONS


- ➤ UL, cUL, certificate
- ➤ Lumileds 2835, high CRI.
- ➤ Input voltage120-277VAC .
- ➤ Output constant current lever can be adjusted throughoutput cable with 0-10V.
- ➤ No UV or IR in the beam.
- ➤ Wattage adjustable feature enabled with wattage dial device (sold separately).
- ➤ Easy to install and operate.
- ➤ Energy saving, long lifespan.
- ➤ Light is soft and uniform, safe to eyes.
- ➤ Instant start, NO flickering, NO humming.

- Entrance lighting, courtyard lighting;
- Industrial lighting, Outdoor landscape lighting;
- Building, The hotel;
- Wall lighting area and so on.

ISA SUPPUR

PRODUCT DIMENSIONS



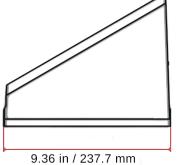

10.65 in / 270.6 mm













PRODUCT TECHNICAL SPECIFICATIONS

	Input Power (Tolerance : ±10%)	40W(Wattage	Selectable 40W/20	0W/10W)	
	Color Temperature	3000K	4000K	5000K	
	Lumen (Tolerance : -10%)	5563LM	5844LM	5720LM	
	Efficacy (Tolerance : -3%)	139LM/W	146LM/W	143LM/W	
OPTICAL	CRI	>80	1		
	Color Consistency	<7 Steps (or	r <7 SDCM)		
	BUG	B3-U0-G2			
	Diffuser Type	PC Lens			
	Distribution Pattern	Type II			
	Beam Angle (50%) (Tolerance :	H120*V85 Deg	gree		
	Input Voltage and Frequency	120-277VAC	, 50/60Hz		
	PF (Tolerance : -3%)	≥0.9			
	THD (Tolerance : +5%)	≤20%			
	Flicker Percent	<30%			
ELECTRICAL	Driver Brand	Rugged Grad	le Lighting		
	Driver Model	Rugged Grad	le AS Driver		
	Driver Surge protection	L-N: 4kV , L&	N-E: 4kV		
	Dimming	0-10V dimming standard			
	Optional Accessory	Motion Sensor, Surge-protective Device			
	LED Brand	Lumileds			
	LED Type	SMD2835			
MATERIALS	LED QTY	104*2PCS			
MATERIALO	Housing	Die-cast alun	Die-cast aluminum		
	Housing Color	Bronze	Bronze		
	Waterproof Rating	WET (IP65)			
	Operating Temperature	-40°C TO 50°C; Sensor:-25°C TO 50°C; emergency:0°C TO 50°C			
OTUEDO.	Storage Temperature	-40°C TO 80°C			
OTHERS	Operating Humidity	20% - 90%	RHRT		
	Storage Humidity	10% - 95% RH			
	Warranty	5 years warra	anty with 24/7 or	perating hours Luminaire lifetime	

PRODUCT MOUNTS & ACCESSORIES

SENSOR INSTALLATION

- 1. Remove plastic cap
- 2. Make sure the 3 prongs have good contact with contactors in recepticle



Rugged Grade Lighting Industrial Grade Solutions







PRODUCT IMAGES & ACTUAL INSTALLATIONS



Color temperature adjustable instruction

- 1, The color temperature of the light turns to 3000K when the DIP switch is set to 3K;
- 2, The color temperature of the light turns to 4000K when the DIP switch is set to 4K;
- 3, The color temperature of the light turns to 5000K when the DIP switch is set to 5K;

Note: Please turn off the power before adjusting the color temperature.

Wattage adjustable instruction

The power of the light will change to the corresponding wattage when the DIP switch is set to L/ M/ H. Adjustable wattage range: 25%-100%.

Note: Please turn off the power before adjusting the wattage.



Photocell:

Connection of male and female connector will help to turn on the photocell.(Fig:1) Disconnection of male and female connector will help to turn off the photocell.(Fig:2)







PHOTOMETRICS

LUMINAIRE PHOTOMETRIC TEST REPORT

Test:U:119.70V I:0.3496A P:41.457W PF:0.9907 Freq:60.01Hz						
Lamp Flux:5563.77x1 lm						
NAME: TYPE: WEIGHT:						
SPEC.:	DIM.:	SERIAL No.:				
MFR.: EVERFINE SUR.: Shielding Angle:						

DA	TA OF LAM	P	PHOTOMETRIC DATA Eff: 134.21 lm/W				
MODEL		Imax (cd)	2507	S/MH(CO/180)	1.81		
NOMINAL POWER(W) 40		LOR(%)	100.0	S/MH (C90/270)	0.93		
RATED VOLT	RATED VOLTAGE (V) 120		TOTAL FLUX(lm)	5563.8	η UP,DN(C0-180)	0.3,56.7	
NOMINAL FI	NOMINAL FLUX (lm) 5563.77		CIE CLASS	DIRECT	η UP,DN(C180-360)	0.2,42.7	
LAMPS INSI	LAMPS INSIDE 1		η up(%)	0.5 CIBSE SHR NOM		1.25	
TEST VOLTAGE (V) 120		η down(%)	99.5	CIBSE SHR MAX	1.35		

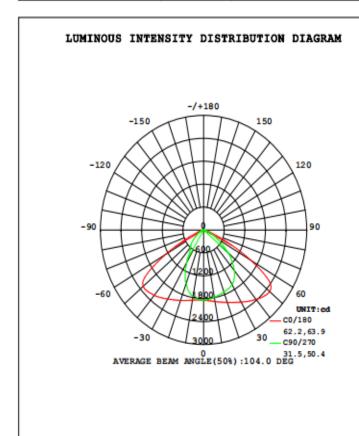

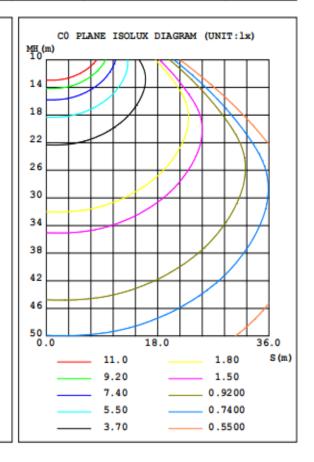






DLC SPECS



RGL-TUCANA-3-TT-40WBT2DA1-abcW30/40/50

Manufacturer: RuggedGrade Brand: RuggedGrade

PRODUCT OVERVIEW	
Model Number	RGL-TUCANA-3-TT- 40WBT2DA1-abcW30/40/50
Classification	Premium
Primary Use	Outdoor Full-Cutoff Wall- Mounted Area Luminaires
Reported Input Wattage	40.4 W
Reported Light Output	5701 lm
Reported CCT	3000 K
Reported CRI (Ra)	83
Product ID	S-6K99Y2
DLC Family Code	EMWBQA
Listing Status	Listed
Date Qualified ①	2024-05-07

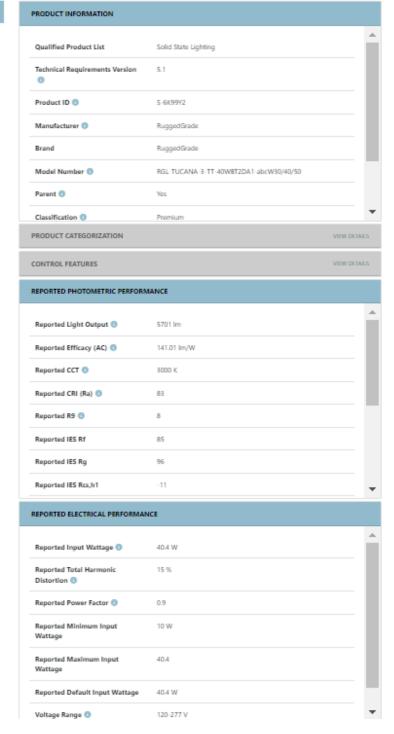






PRODUCT PACKAGING

	Size	Qty / Carton	Net Weight / Carton	Gross Weight / Carton
Outer box	337*321*215mm	1 PCS	3.4KG	4.5KG
	(13.3"*12.6"*8.5")		(7.5lb)	(9.9lb)

^{*}Tolerance of Carton Size: ±15 MM, Tolerance of Weight: ±10%.

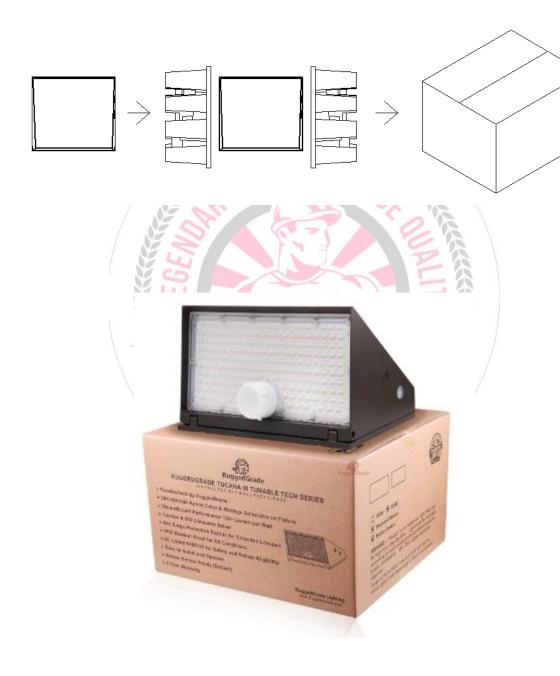





PRODUCT WARNINGS

- Please turn off power before install or change assembly parts.
- The input voltage and lamps should be matched, after connecting the power line.
- Please make sure the wiring section is insulated.
- Professionals must install and disassemble the lamps.
- Surge is the number 1 cause of LED light failure. Outdoor lights must have surge at fixture, pole, and breaker.
- ♣ Surge is the number 1 cause of LED light failure. Indoor lights must have surge at fixture and breaker.

PRODUCT TROUBLESHOOTING

Issue	Check points		
Light Flickers	Check all wiring for disconnections, shorts and burnt wiring and connections. Confirm steady input voltage to the light fixture, fluctuating input voltage will harm the LED driver and can lead to premature failure. Lights with photocells can have photocell tag from ambient light or light reflecting at the sensor. Simply cover the photocell completely and see if flickering continues while the photocell is covered. Call Tech Support for help if none of the above solves the issue.		
Light does not work at all.	Check all wiring for disconnections, shorts and burnt wiring and connections. Confirm steady input voltage to the light fixture, fluctuating input voltage will harm the LED driver and can lead to premature failure. If input voltage is not in the voltage range of the fixture, you will need to find the source of your input voltage issue. Call Tech Support for help if none of the above solves the issue.		

For more technical information, install questions, troubleshooting help or warranty claims, wehave a dedicated US Tech and Customer Support Team to help solve any issues you have and can be reached by email or phone. If you need help with any of our products, we are here for you so that you are never in the dark!

